

MINISTRY OF AGRICULTURE, TRADE, LANDS, HOUSING AND THE ENVIRONMENT

P.O. Box 272

Brades, MSR1110

Montserrat

West Indies

Tel: (664)-491-2075/2546

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E-Mail: malhe@gov.ms

24th November 2017

MATLHE 11/2

Dear Sir/Madam

Re: Tender for MATHLE Social Housing, "The Construction of Two Bedroom Unit" at Look Out, Lot 157

You are invited to submit a tender for the above captioned project. Included are the tender documents consisting of:

- 1. Instruction to tenderers
- 2. Document checklist
- 3. Form of Tender
- 4. Bill of Quantities
- 5. General Conditions of Contract
- 6. Anti-Collusion Statement
- 7. Evaluation Criteria
- 8. Post Contract Performance Report
- 9. Schedule A Labour Rates
- 10. Schedule B Material Prices
- 11. Schedule C Construction Equipment
- 12. Schedule D List of Proposed Sub-Contractors
- 13. Specifications
- 14. Tender Drawings

All tender packages can be accessed on the Government of Montserrat website at www.gov.ms. Please return a completed set of document of the priced and signed Form of Tender, Completed Document Checklist, Signed anti-collusion statement, Completed Schedules A-D and a copy of your tax compliance certificate (if locally based). These should be placed in a sealed inner envelope and addressed to the Chairman, Public Procurement Board, Ministry of Finance and Economic Management, Government

Headquarters, MSR1110, Montserrat. The name of the project should also be written on this inner envelope and should read, "Tender for MATHLE Social Housing, "The Construction of Two Bedroom Unit", at Look Out, Lot 157. The name of the tenderer should also be written on the inner envelope.

The inner envelope should then be placed into an outer envelope addressed to the Chairperson, Public Procurement Board, Ministry of Finance and Economic Management, Government Headquarters, MSR1110, Montserrat. The name of the project should also be written on this inner envelope and should read, "Tender for MATHLE Social Housing, "The Construction of Two Bedroom Unit", at Look Out, Lot 157. The outer envelope should bear no identification of the tenderer.

Tenders are to be received no later than **2pm on Wednesday 20**th **December 2017.** Please ensure no additional marks are placed on the outer envelope.

A site visit will be arranged for 10:00am-11:45am on Wednesday 6th December 2017 at the Look Out site.

All queries relating to the tender or works included should be made in writing to Linda Dias, Government Architect, MCWL at diasla@gov.ms.

Yours faithfully

Mrs. Daphne Cassell

Permanent Secretary

Ministry of Agriculture, Trade, Housing, Land and Environment

MATHLE SOCIAL HOUSING "THE CONSTRUCTION OF TWO BEDROOM UNIT" AT

LOOK OUT LOT 157

INSTRUCTIONS TO TENDERER

Tender Documents and Instructions

- A Tenderers will be supplied with the following tender documents-:
 - Tender Dossier
 - Tender Drawings
- B Invitation Letter/verbal confirmation was done.
- C Tender Drawings prepared by the Architect, Ministry of Communication, Works and Labour.
- D Bills of Quantities prepared by the Quantity Surveyor, Ministry of Communication, Works and Labour.
- E One copy of the above mentioned tender documents will be supplied to tenderers. Tenderers must comply strictly with the following instructions; failure to do so is liable to cause your tender to be rejected.
- F. Documents to be submitted together with the Form of tender:
 - 1. Instruction to Tenderers
 - 2. Document Check List
 - 3. Form of Tender
 - 4. Bill of Quantities
 - 5. Tax Compliance Certificate (if locally based)
 - 6. General Conditions of Contract
 - 7. Signed Anti-Collusion Statement
 - 8. Evaluation Criteria
 - 9. Post Contract Evaluation
 - 10. Schedule A-labour rates
 - 11. Schedule B-material prices
 - 12. Schedule C-construction equipment
 - 13. Schedule D-list of proposed sub-contractors
 - 14. Construction Programme
 - 15. Method Statement/ Risk Assessment
- G This tender is based on the Drawings presented, Specifications, General Conditions of contract (JCT SBC/Q 2011) and Bills of Quantities including schedules A D (measured works section), hereinafter is referred to as the Contract Documents.

MATHLE SOCIAL HOUSING "THE CONSTRUCTION OF TWO BEDROOM UNIT" AT LOOK OUT LOT 157

Scope of the Works

- A Contract provides for-:
- B The supply of all materials, labour, equipment and temporary facilities to safely Complete "The Construction of a Two-bedroom unit at Look Out LOT #157 as detailed In the Tender Documents.
- C The proposed works are described in the Drawings, Scope of Works and Bills of Quantities which are provided to the tenderers.

MATHLE SOCIAL HOUSING "THE CONSTRUCTION OF TWO BEDROOM UNIT" AT

LOOK OUT LOT 157 (Cont'd)

INSTRUCTIONS TO TENDERER (Cont'd)

Explanation of Documents

A If any point/s in the documents issued for the purpose of tendering are not clear, the tenderer is especially asked to telephone the Public Works Department at +664 491 6611 or +664 491 8566 to clarify any Queries on the drawings or in the Bills of Quantities. The Project Architect will provide explanations by the issue of an addendum to confirm answers given, and not less than 7 working days prior to the date fixed for the delivery of tenders, and a copy of such addendum will be dispatched to all parties who have taken sets of the tender documents. Any addendum so issued will be incorporated in the contract documents.

All information given on the drawings or in the contract documents relating to materials encountered, ground-water, sub-surface conditions, natural phenomena, existing services and pipes is from the best source available to the Employer at preparation of tender documents. All such information is furnished only for the information and convenience of tenderers.

Statements to Tenderer

- A Neither the Employer; Government of Montserrat., nor any of its agents or servants shall be bound by held liable for any statement made or delivered to any tenderer unless such a statement shall have been confirmed by a circular letter to tenderers issued by the Project Architect.
- B Each Tenderer shall familiarize itself with the site and all works required including services to be installed under this and any sub-contract and bring to the attention of the Project Architect any apparent areas of conflict, at an early enough stage to ensure that appropriate steps can be taken and instructions issued, without

jeopardizing any aspects of the various services installations and hand over of the finished building as a whole.

C Tenderers are advised that the Government of Montserrat in an effort to improve Contractor Performance and provide Client satisfaction in achieving value for money, will undertake a 'Contractor Performance Report' at the end of contract. A form has been included in the tender pack and this will be the tool used to measure and assess the contractor's performance in achieving the project objectives. The contractor performance during contract implementation will be assessed at close out and the level of client's satisfaction for the completed works will form part of the measureable indicators along with cost time and successful completion and delivery of the scope.

MATHLE SOCIAL HOUSING "THE CONSTRUCTION OF TWO BEDROOM UNIT" AT

LOOK OUT LOT 157 (Cont'd)

INSTRUCTIONS TO TENDERER (Cont'd)

Tenderer to Investigate Before Tendering

A The tenderer will be deemed to have read and examined all the documents and he/she shall satisfy him or herself as to all matters and eventualities which can in any way influence his or her tender. Any neglect or failure on the part of the tenders to obtain reliable information upon any matters affecting the cost, time, quality, execution, construction, completion, testing and commission of the Works and the Contract shall not relieve the persons whose Tender is accepted from any risks or liabilities for the complete Works, nor will any claim for increase of the Contract be entertained as a result of such negligence.

- B The tenderers are required to visit and examine the site and its surroundings, and he/she may obtain for him or herself all the information that may be necessary for compiling his or her tender. He/she must examine the tender documents and ascertain the matters on which he/she will be deemed to have satisfied him or herself with all the risks and obligations which the Contract will impose on the Contractor, submission of the tender therefore shall be considered conclusive evidence of such.
- C The tenderer shall submit his or her tender with the understanding that the tender documents are intended to cover all the work within the scope of the Contract, and that unless expressly excluded, any and all labour and materials not indicated therein, but necessary to complete any part of work, shall be considered as included and shall be furnished.
- D Any alteration made by a tenderer to the documents issued for the purpose of tendering or omission by him or her to complete fully and return every document as required by this notice to tenderers, unless otherwise instructed by the Project Architect, may preclude consideration of the tender by the Employer. Should any further information be required, it will be supplied on request by the Project Architect.

Bills of quantities

A Quantities contained within the Bills of Quantities do not necessarily indicate conclusively the amount or the extent of works to be preformed. The tenderer must satisfy himself or herself as to the general accuracy of the quantities given in the bill of quantities and must provide accordingly in the tender rates. If he/she considers that any quantity may differ materially from the figure given in the bills of quantities, he/she must call attention to the fact in a letter accompanying the tender. The tenderer must not insert additional items in the bills of quantities, but must provide for all his/her obligations under the Contract in the rates and prices entered against the items provided. An all-in rate comprising of labour, material, transportation and plant must be entered against every item in the bills of quantities. If any item is left un-priced it shall be deemed as allowed for elsewhere. The schedules must also be completed if provided in the tender documents.

MATHLE SOCIAL HOUSING "THE CONSTRUCTION OF TWO BEDROOM UNIT" AT

LOOK OUT LOT 157 (Cont'd)

INSTRUCTIONS TO TENDERER (Cont'd)

Currency of Tender

- A Tenders shall be priced in Eastern Caribbean Dollars. Rates and prices shall be inclusive of applicable taxes. In order to keep the bidding process as fair and simple as possible, please bid as a **duty paid** project.
- B The tenderer must familiarize himself/herself with the workings of the Customs Department and shall allow for the costs of and shall accept responsibility for preparing and processing the necessary documents involved in the importation of labour and materials, etc. to be incorporated in the Works.
- C The tenderer must allow for all Wharfage Dues, Package Tax, Importer's Licenses (where applicable), Stamp Duties, taxes and charge that may be required.
- D Special rules are in force in respect of the importation of plant, scaffolding, tools, equipment and consumable stores that are not incorporated in the Works. The tenderers must allow for the result of licenses, bonds deposits, duties, taxes, stamp duties or any other charges that may be required.
- E. The **Hon F.S.** has advised that Contractors are to reduce their dependency on GOM taking the **Risk** of providing substantial Advanced Payments to them. In addition, consideration with strong supporting evidence will be required for all Advanced payment request Contractors put in their Payment Schedules of more than **15%**. Except in cases where there is an exemption from tax, of which proof must be provided; residents of Montserrat for tax purposes are subject to tax on the profits from this project while non-residents are liable to a 20% Withholding Tax deduction from the gross amount.

MATHLE SOCIAL HOUSING "THE CONSTRUCTION OF TWO BEDROOM UNIT" AT

LOOK OUT LOT 157 (Cont'd)

INSTRUCTIONS TO TENDERER (Cont'd)

Return of Tenders

Tenders shall be sent to: -

A The Chairman of the Central Procurement Board Ministry of Finance and Economic Management, Government Headquarters,

Brades,

Montserrat

- B Tenders shall be made on the appropriate Form of Tender included in the tender documents. The complete tender shall be submitted in a plain sealed envelope or package clearly marked on the outside: -
- C 'TENDER FOR MATHLE SOCIAL HOUSING "THE CONSTRUCTION OF TWO BEDROOM UNIT" AT LOOK OUT LOT 157 MONTSERRAT
- D The envelope or package shall bear no indication of the identity of the sender.

E Tenders shall reach the above address no later than; **As indicated on the Invitation to Tender.**

MATHLE SOCIAL HOUSING "THE CONSTRUCTION OF TWO BEDROOM UNIT" AT LOOK OUT LOT 157 (Cont'd)

INSTRUCTIONS TO TENDERER (Cont'd)

Information to be Completed by the Tenderer

A Tenderer shall complete the tender documents so provided. Each Tender must contain the name, residence and place of business of the person or persons making the Tender and must be signed by the Tenderer with his usual signature. Tenders by partnership must furnish the full names of all partners and must be signed with the partnership name by one of the members of the partnership or by an authorised representative followed by the signature and designation of the person signing. Tenders by corporation to be signed with the legal name of the corporation followed by the date and name of the State of incorporation and by the signature and designation of the President, Secretary or other person authorized to bind it in the matter. Satisfactory evidence of the authority of the signer on behalf of the firm shall be furnished.

Responsibility for Tender

- A The Employer, Government of Montserrat will not be responsible for, or pay for, any expense or loss which may be incurred by the tenderer in the preparation of his tender.
- B The Tenderer to whom the award is made may be required to furnish, and deliver to the Employer, a written bond of indemnity, of the same form as that in security forms section of the tender document, in the amount of ten percent (10%) of the Contract

Price, and with surety thereon acceptable to the Employer. The bond shall be furnished and maintained at the expense of the Contractor. The party to whom the Contract is awarded will be required to execute the Contract and (if required) furnish the Performance Bond duly executed within seven days, not including Sunday or Legal Holiday. Failure to so execute the Contract shall be sufficient reason for the Project Architect to cancel the award without obligation or claim upon the Employer.

MATHLE SOCIAL HOUSING "THE CONSTRUCTION OF TWO BEDROOM UNIT" AT LOOK OUT LOT 157 (Cont'd)

INSTRUCTIONS TO TENDERER (Cont'd)

- A Increases / Decreases in Cost of Labour and Materials
 - Increases / decreases in the current cost of labour and materials subsequent to the date for closing of Tenders will not result in an adjustment to the Contract Price.
 - ii. Basic unit costs of labour and certain materials upon which the Tender is based and upon which dayworks and variations will be considered shall be listed in the Schedule listed in the preliminary Appendix. These Schedules shall be completed and submitted with the Tender. Failure to submit them may lead to disqualification of the Tender.

Bribery

A The offer of a bribe or other inducement to any person with the object of influencing the placing of the Contract will result in instant rejection of the tender concerned.

Time for Commencement

A Tenderers are advised that the actual work of this Contract must not be started until a "Notice to Commence Work" has been issued by the Project Architect. The Contractor shall, however, commence work no later than the date specified in the above Notification.

Time for Completion

A The time for completion for the complete contract is to be determined by the tenderer in the Form of Tender.

MATHLE SOCIAL HOUSING "THE CONSTRUCTION OF TWO BEDROOM UNIT" AT LOOK OUT LOT 157 (Cont'd)

INSTRUCTIONS TO TENDERER (Cont'd)

Validity of Tender

A The tender shall be valid for 90 calendar days from the date fixed for public or private opening of tenders. During this period the tender is irrevocable. The Employer shall notify the successful tenderer (if any) of its acceptance within the period of the tender validity. The Tenderer to whom the award is made will be required to enter into an agreement with the Employer. This agreement will be of the form that is in the Tender Documents, and stated earlier.

Acceptance of Tender

A The Employer, Government of Montserrat does not bind itself to accept the lowest or any tender nor to assign any reason for the rejection of any tender. Tenders may be declared void if the tender sum exceeds the funds available for the works.

Errors in the Tender

A Errors discovered in the Contractor's Tender will be dealt with as follows:

The Contractor will be given details of such errors and afforded an opportunity of confirming or withdrawing his offer. If the Contractor withdraws, the tender of the second most advantageous tenderer will be examined, and if necessary this

Contractor will be given a similar opportunity.

Ministry of Agriculture, Trade, Housing, Land and Environment Tender Document Checklist

Wednesday 20 December 2017

Below are the following documents that should be provided for a contractor's tender to be valid. Bidders are asked to supply and tick off the following information. Failure to

Project Title: Tender for MATHLE Social Housing, "The Construction of Two Bedroom Unit" at Look Out, Lot 157.

24 November 2017

2:00pm

Date scheme advertised:

Tender Deadline Date:

Tender Deadline Time:

provide any of the stated documents will result in the tender being consider compliant and rejected.	ered non-
The below documents should be presented with their bid to ensure that their bid	is valid.
Signed Form of Tender (Including time for completion and notice period)	
Completed Bill of Quantities	
Tax Compliance Certificate	
Signed Anti-Collusion Statement	
Schedule A - D	
Construction Programme	
Method Statement	
Proposed Payment Schedule	
Details of Contractor Experience	
Signed on behalf of Contractor Date	

FORM OF TENDER

The Chairperson
Public Procurement Board
Ministry of Finance and Economic Management
Brades
Montserrat

Dear Sir/Madam;

Re:	Tender for MATHLE Social I	Housing, "The (Construction of '	Two Bedroom U	Jnit"
at L	ook Out, Lot 157.				

at Look Out, Lot 157.
I/We the undersigned undertake to construct and complete the above Works in accordance with the General Conditions of Contract, Specifications and Drawings for the sum of: EC\$
(words)
If my/our tender is accepted, I/We undertake to commence the Works within 7 days from the date of receipt by me/us of the official order and complete the works within 90 days from the date of receipt by me/us of the official order.
I/We understand I/We shall not be reimbursed for any cost that may have been incurred in compiling this tender. I/We confirm this tender shall remain valid for a period of 90 days from the date of submission of this tender.
Name
Signed
Name of firm (If Applicable)
Address
Tel. nr
Fax nr
Email Address
Date

APPENDIX TO FORM OF TENDER

Clauses

Amount of Bond or Guarantee (if required): 10 percent of Contract Sum

Amount of Third Party Insurance EC. \$700,000.00

Period for commencement from

Notification of Award of Contract Calendar Days **

Amount of Liquidated Damages EC \$2,450 per day or part

thereof

Period of Maintenance 12 months

Percentage of Retention 5 percent

Limit of Retention Money 5 percent of Contract Sum

Time within which payment to be made

after issue of Certificate 14 Calendar Days

^{**} To be filled in by Tenderer

Substructure Two Bedroom Unit Look Out

D	GROUNDWORK				\$ С	
<u>D</u>	20 EXCAVATING AND FILLING					
<u>Si</u>	ite preparation		(02)			
CI	learing site vegetation					
	bushes, scrub, undergrowth, hedges and trees and tree stumps not exceeding 600 girth	4840	sf			
<u>E></u>	xcavating		(02)			
Tr	renches not exceeding 2'-0" wide					
В	7'-0" maximum depth	46	су			
C 4	4'-0" maximum depth	20	су			
	xtra over excavation irrespective of depth for reaking out					
Dı	rock	1	су			
<u>Ea</u>	arthwork support		(02)			
To	o faces of excavation					
	; distance between opposing faces not exceeding 2'-0"	1736	sf			
<u>Di</u>	<u>isposal</u>		(02)			
Su	urface water					
F	generally	ITEM				
E>	xcavated material					
	off site; to location by contract administraor and depositing	4	су			
				To Collection		

To Collection

3-Nov-17			Substructure Two Bedroo	om Unit Look Ou
Excavated material		(02)		\$ c
Filling to excavations				
over 1'-0" average thick; obtained off site	62	су		
<u>Herbicides</u>		(02)		
Applying to surfaces				
bottom and sides of excavations	1876	sf		
			To Collection	

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3-Nov-17	Substructure Two Bedroom Unit Look Out
D GROUNDWORK	\$ c
<u>Collection</u>	
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Page No. 2/001/79	
	To Summary

<u>Substructure</u> <u>Two Bedroom Unit Look Out</u>

	E IN SITU CONCRETE/LARGE PRECAS CONCRETE				\$ c	
	E10 IN SITU CONCRETE					
	<u>Reinforced</u>		(06)			
	Foundations					
Α	generally; poured on or against earth or unblinded hardcore	4	су			
	E20 FORMWORK FOR IN SITU CONCRETE					
	<u>Formwork</u>		(10)			
	Sides of foundations					
В	not exceeding 0'-10" high	33	sy			
	E30 REINFORCEMENT FOR IN SITU CONCRETE					
	<u>Reinforcement</u>		(07)			
	Bars					
С	ladder mesh 5/8";	183	ly			
D	bent in walls	299	kg			
E	5/8"; straight in foundations in retaining walls	146	kg			
F	5/8"; straight in foundations	267	kg			
G	5/8"; bent in retaining walls footings	14	kg			
Н	5/8"; links in foundations	54	kg			
				To Summary		

To Summary

Superstructure Two Bedroom Unit Look Out

	N SITU CONCRETE/LARGE PRECAS NCRETE			\$	С
<u>E10</u>) IN SITU CONCRETE				
Rein	<u>iforced</u>		(06)		
Slab	os				
	t exceeding 6" thick; sloping not exceeding 15 grees	956	sf		
	thick; poured on or against earth or unblinded rdcore; externally	38	sf		
Isola	ated beams				
C ge	nerally	8	су		
Colu	umns				
D ge	nerally	4	су		
Stair	rcases				
E ge	nerally	1	су		
) FORMWORK FOR IN SITU NCRETE				
Forn	<u>nwork</u>		(10)		
Side	es of staircase				
F no	t exceeding 6" high	3	sf		
Edg	es of slabs				
G no	t exceeding 6" high	59	ly		
Soff	its of beams				
H no	t exceeding 8" thick	23	sf		

To Collection

23-Nov-17			Superstructor Two Bedroo	m Unit Look Out
Isolated beams				\$ c
A rectangular	533	sf		
Columns attached to walls				
3 rectangular	622	sf		
E30 REINFORCEMENT FOR IN SITU CONCRETE				
Reinforcement		(07)		
Bars				
C ladder mesh	182	ly		
5/8"; straight in staircase	34	kg		
5/8"; straight in walls	217	kg		
5/8"; straight in staircase	26	kg		
G 5/8"; bent in beams	505	kg		
5/8"; straight in columns	420	kg		
J 5/8"; straight in beams	506	kg		
Fabric				
Ref No #66 wire mesh	1292	sf		

To Collection

23-Nov-17	 Superstructory Two Bedroo	m Unit Look Out
U CONCRETE/LARGE PRECAST CONCRETE		\$ c
Collection		
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Page No. 2/002/79		
	To Summary	

3-Nov-17			C	4	
			Superstruc Two Bedro		ook Out
E MACONDY					\$ c
<u>F MASONRY</u>					
F10 BRICK/BLOCK WALLING					
<u>Blockwork</u>		(11)			
Walls					
8" thick	96	sy			
8" thick in retaining walls	7	rov sun	h		

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Superstructure Two Bedroom Unit Look Out

			III OIIII LOOK	
G STRUCTURAL/CARCASSING METAL/TIMBER			\$ c	
G20 CARPENTRY/TIMBER FRAMING/FIRST FIXING				
Sawn hardwood		(20)		
Framed supports				
2" x 4" treated	204	lf		
intermediate post				
3 4" x 4" treated	6	lf		
2" x 3" treated	100	lf		
handrail				
2" x 3" treated	6	lf		
Top and Bottom rail				
2" x 3" treated	31	lf		

To Summary

Bill No. 002 / / 157 Page 5

To Summary

23-Nov-17	Superstructure Two Bedroom Unit Look	
U CONCRETE/LARGE PRECAST CONCRETE	<u>≡</u>	
<u>Summary</u>	<u> </u>	
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Page No. 4/002/79	9	
Page No. 5/002/79	9	
Page No. 6/002/79	9	
	To Conoral Summany	
Bill No. 002 / / 157 Page 7	To General Summary	

Doors and Windows Two Bedroom Unit Look Out

	L WINDOWS/DOORS/STAIRS				\$ c	
	<u>L13 UPVC</u> WINDOWS/ROOFLIGHTS/SCREENS/LO <u>VRES</u>					
	<u>UPVC</u>		(24)			
	Windows and window frames					
Α	3'-0" x 3'-0"; Type; Double Hung sliding sash with tilt opening feature complete with locking hardware and insect screens as stated in the specification document	1	nr			
В	2'-2" x 2'-2"; Type; Double Hung sliding sash with tilt opening feature complete with locking hardware and insect screens as stated in the specification document	5	nr			
С	3'-6" x 4'-0"; Type ;Double Hung sliding sash with tilt opening feature complete with locking hardware and insects screens; as stated in the specification document	7	nr			
	<u>L20 TIMBER</u> DOORS/SHUTTERS/HATCHES					
	<u>Panelled</u>		(24)			
	Doors					
D	3'-0" X 6'-8"; standard ironmongery with privacy lock and deadbolt	1	nr			
E	as dimensioned diagram on drawing# A-601; Type cedar fielded 4 panel door; 2'-4" x 6'-8"	1	nr			
F	as dimensioned diagram on drawing# A-601; Type cedar full louvre door; 2'-4" x 6'-8"	1	nr			
G	as dimensioned diagram on drawing# A-601; Type pine fielded 4 panel door; 2'-4" x 6'-8"	1	nr			
Н	as dimensioned diagram on drawing# A-601; Type pine fielded 4 panel door; 2'-8" x 6'-8"	3	nr			
				To Collection		_

To Collection

23-Nov-17 **Doors and Windows** Two Bedroom Unit Look Out Wrot hardwood (25)Architraves 1" x 3"; screwing to the wall with wall screws lf Α 226 Door Stops 1" x 2"; screwing to door frame with wood screws В 115 lf Door frames С jambs 2" x 6"; screwing to walll with wall screw 96 lf 20 D lf heads 2" x 6"; screwing to wall with wall screw (29)<u>Aluminium</u> Doors with frames Ε 3'-0" X 6'-8"; standard ironmongery! nr To Collection Bill No. 003 / / 157 Page 2

23-Nov-17 <u>Doors and Windows</u> <u>Two Bedroom Unit Look Out</u>					
L WINDOWS/DOORS/STAIRS			\$ c		
Collection					
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Page No. 2/003/79					
Bill No. 003 / / 157 Page 3		To Summary			

<u>Doors and Windows</u> <u>Two Bedroom Unit Look Out</u>

			TWO Deares	MII OIIIL LOOK	<u>Out</u>
M SURFACE FINISHES				\$ 0	
M60 PAINTING/CLEAR FINISHING					
Painting wood		(44)			
General surfaces					
A not exceeding 300 girth; to architrave	10	sy			
not exceeding 300 girth; to door stop	4	sy			
not exceeding 300 girth; to door frames	11	sy			
Staining wood		(44)			
pine raised panel door					
over 300 girth	10	sy			
			To Summary		

Bill No. 003 / / 157 Page 4

<u>Joinery and Fitting</u> <u>Two Bedroom Unit Look Out</u>

	N FURNITURE/EQUIPMENT				Ç	С	
	N10 GENERAL FIXTURES/FURNISHINGS/EQUIPMENT						
	Wrot hardwood		(24)				
	Wardrobes						
Α	consisting of 4 shelves, 3/4" plywood on 3/4" x 1 1/5" supports; as dimensioned diagram on drawing# W-01	2	nr				
	Cupboards						
В	1'-0" wide x 2'-6" long x 3'-0" high wall unit; consisting of 3/4" x 1 1/2" hard wood supports and frame with 3/4" thick plywood shelves; to include timber doors and all ironmongomery	2	nr				
С	12'-0" long x 3'-0" high floor unit; irregular shape consisting of 3/4" x 1 1/2" wrot hardwood supports and frame with 3/4" thick plywood shelves with corrian countertops; including doors and drawers and all ironmongomery and forming space for kitchen sink	1	nr				
D	1'-7" wide x 3'-6" long x 3'-0" high bathroom floor unit; consisting of 3/4" x 1 1/2" wrot hardwood supports and frame with 3/4" thick plywood shelves with corrian countertops; including doors and drawers and all ironmongomery and forming space for sink	1	nr				
	N13 SANITARY APPLIANCES/FITTINGS						
	<u>Lavatory basins</u>		(36)				
	Basins						
E	as specification which is indicated in the document	1	nr				
F	as specification which is provided in the document	1	nr				
		<u>[</u>		To Collection			

Bill No. 004 / 157 Page 1

23-Nov-17 Joinery and Fitting Two Bedroom Unit Look Out Sinks (36)Sinks with single drainers combined Α as specification as stated in the document nr Cleaners sinks В as specification as stated in the document nr (36)Water closets Suites С as specification as instructed in the 2 specifications in the document nr Miscellaneous fittings (36)Towel rails D as specification iwhich is provided in the 2 document nr Soap dispensers Ε 3 as specification as stated in the document nr Toilet paper holders F 2 as specification as stated in the document nr Toothbrush holders G as specification as stated in the document nr To Collection

Bill No. 004 / 157 Page 2

Roof Two Bedroom Unit Look Out

G STRUCTURAL/CARCASSING METAL/TIMBER	<u>3</u>			\$ c
G20 CARPENTRY/TIMBER FRAMING/FIRST FIXING				
Wrot hardwood		(25)		
Rigger bridging				
A 2" x 6" treated	56	lf		
Bridging				
B 2" x 6" treated	40	lf		
Pine blocking				
C 2" x 3" treated	106	lf		
rafters				
D 2" x 6" treated	528	lf		
Fascia boards				
E 2" x 8"	168	lf		
Ridge boards				
F 2" x 8" treated	48	lf		
Laths				
G 2" x 3"	560	lf		
pine chord				
H 2" x 6" treated	26	lf		
<u>Steel</u>		(29)		
Straps				
J hurricane	46	nr		
			To Summary	

To Summary

Roof Two Bedroom Unit Look Out

				ı wo Bedroo	m Unit Look Out
Н	I CLADDING				\$ c
<u>H</u>	121 TIMBER WEATHERBOARDING				
<u>P</u>	lywood; tongued and grooved joints		(20)		
R	coofs				
Α	over 12'-0" wide; sloping	1155	sf		
	132 PLASTICS PROFILED SHEET CLADDING/COVERING/SIDING				
	Specification]; Spec #15 paper underly as per nanufacturers recommendations				
R	oof coverings				
В	flat	1155	m2		
	174 ZINC SHEET COVERINGS/FLASHINGS				
<u>m</u>	<u>netal</u>		(20)		
FI	lashings				
С	as specified by project architect	154	lf		
<u>A</u>	sphalt shingles				
<u>to</u>	o include algae/fungal resistant coating				
R	oof coverings				
D	pitched; fixing over building paper	1155	sf		
				To Summary	

Roof Two Bedroom Unit Look Out

				<u></u>	III OTIII LOOK Out
	M SURFACE FINISHES				\$ c
	M60 PAINTING/CLEAR FINISHING				
	Painting wood		(44)		
	General surfaces				
Α	not exceeding 300 girth;Rigger bridging	38	sf		
В	not exceeding 300 girth;to pine chord	35	sf		
С	not exceeding 300 girth;bridging	27	sf		
D	not exceeding 300 girth; to fascia board	259	sf		
Е	not exceeding 300 girth; to ridge board	81	sf		
F	not exceeding 300 girth; to rafters	618	sf		
	_			To Summary	_

To Summary

<u>Finishes</u> <u>Two Bedroom Unit Look Out</u>

				1 WO DOG!OO	mi Omi Look Odi
	M SURFACE FINISHES				\$ c
	M10 SAND CEMENT/CONCRETE/GRANOLITHIC SCREEDS/FLOORING				
	<u>Concrete</u>		(39)		
	Floors				
Α	level or to falls only not exceeding 15 degrees from horizontal; to concrete	843	sf		
	M20 PLASTERED/RENDERED/ROUGHCAST COATINGS				
	<u>Render</u>		(38)		
	Walls				
В	over 300 wide; to external surfaces	1597	sf		
С	over 300 wide; to blockwork	3351	sf		
	M40 STONE/CONCRETE/QUARRY/CERAMIC TILING/MOSAIC				
	<u>Ceramic Tiling</u>		(41)		
	Walls				
D	over 300 wide	233	sf		
	Floors				
Е	level or to falls; to concrete	810	sf		
F	level or to falls; to concrete; non-slip on staircase	34	sf		
				To Collection	

23-Nov-17 **Finishes** Two Bedroom Unit Look Out (41) Mosaic Floors Α to falls and crossfalls and to slopes not exceeding 15 degrees from horizontal; to concrete 15 sf M60 PAINTING/CLEAR FINISHING Painting render (44)General surfaces В over 300 girth; intermediate post 11 sf С over 300 girth; top and bottom rails and balisters 111 sf sf D over 300 girth; handrails 5 sf sf (44)Ε over 300 girth; external 1597 F 3351 over 300 girth; internal Painting wood sf General surfaces G ITEM sf over 300 girth; to wardrobe 73 Η over 300 girth; cabinets J ceiling surface 1212

Plumbing Two Bedroom Unit Look Out

	R DISPOSAL SYSTEMS				\$ c
	R11 FOUL DRAINAGE ABOVE GROUND				
	Plastics pipework		(32)		
	Pipes				
Α	4"; in in situ concrete; in chases	17	lf		
В	2"; in in situ concrete; in chases	6	lf		
	R12 DRAINAGE BELOW GROUND				
	Excavating trenches		(32)		
	2"				
С	not exceeding 2'-6" average depth	23	ly		
	4"				
D	not exceeding 2'-6" average depth	58	ly		
	Plastics pipework		(32)		
	Pipes				
Е	4"; in trenches	58	lf		
F	2"; in trenches	23	lf		
				To Collection	

Nov-17		<u>Plumbing</u> <u>Two Bedroo</u>	m Unit Look Out
Commissioning			\$ c
completed installation	ITEM		
oomprotod motandion	11211		
		To Collection	

Plumbing Two Bedroom Unit Look Out

					mi omi Look out
	S PIPED SUPPLY SYSTEMS				\$ c
	S10 COLD WATER				
	<u>Copper pipework</u>		(33)		
	Flow and return header pipes				
Α	1/2"; in trenches	94	If		
В	1/2"; in chases; in walls	41	If		
	Brass ancillaries		(BW)		
	bibb cocks				
С	1/2"; to copper pipe	2	nr		
	Check valves				
D	1/2"; wheel head; to copper pipe	1	nr		
	Isolating valves				
Е	1/2"; wheel head; to copper pipe	17	nr		
	Installation generally		(BW)		
	Testing				
F	completed installation	ITEM			
	Commissioning				
G	completed installation	ITEM			
	S11 HOT WATER				
	<u>Copper pipework</u>		(33)		
	Flow and return header pipes				
Н	1/2"; in floor screeds; in walls	36	lf		
				To Collection	

To Collection

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Electricals Two Bedroom Unit Look Out

	V ELECTRICAL SUPPLY/POWER/LIGHTING SYSTEMS				\$с	
	V20 LV DISTRIBUTION					
	PVC; Spec 110 Volt circuit		(EL)			
	Conduits					
А	2.5 mm2 wiring to socket outlets	5	nr			
В	2.5 mm2 wiring to solar tank immersion heater	1	nr			
С	2.5 mm2 wiring to illuminated switch	1	nr			
	PVC; Spec 240 Volt circuit		(EL)			
	Conduits					
D	1.5 mm2 wiring to light fittings	4	nr			
E	6.0 mm2 wiring to transformer	1	nr			
	V51 LOCAL ELECTRIC HEATING UNITS					
	<u>Equipment</u>		(BW)			
	Storage heaters					
F	water heater as per specification	2	nr			
	V90 GENERAL LIGHTING AND POWER [SMALL SCALE]					
	<u>Copper</u>		(EL)			
	Earth rods					
G	Type as per specification; driving into ground	1	nr			
				To Summary		

To Summary

Electricals Two Bedroom Unit Look Out

	Y MECHANICAL AND ELECTRICAL SERVICES MEASUREMENT				\$ c	
	Y70 SWITCHGEAR AND DISTRIBUTION BOARDS					
	HV Weatherproof switchgear		(EL)			
	Distribution boards					
А	110V	1	nr			
В	220V	1	nr			
	Y73 LUMINAIRES AND LAMPS					
	<u>Luminaires</u>		(EL)			
	Wall type					
С	weather protected	4	nr			
D	wall mounted light fixture	11	nr			
	Recessed ceiling type					
Е	to be finalise by the Project Architect	5	nr			
	Fluorescent luminaires		(EL)			
	Ceiling type					
F	single tube	1	nr			
G	Double tube	1	nr			
	Y74 ACCESSORIES FOR ELECTRICAL SERVICES					
	<u>Accessories</u>		(EL)			
	Surface TV outlets					
Н	single outlets	1	nr			
				To Collection		

23-Nov-17 **Electricals** Two Bedroom Unit Look Out Surface plate switches Α To be finalised by Project Architect; single pole 9 nr В To be finalised by Project Architect; single pole; solar water tank heater nr С To be finalised by Project Architect; two pole 6 nr Surface socket outlets D To be finalised by the Project Architect;220V 6 nr Ε 17 To be finalised by the Project Architect; 110V nr F 4 To be finalised by the Project Architect; GFCI nr Surface telephone outlets 3 G single outlet nr To Collection Bill No. 008 / / 157 Page 5

S C ND ELECTRICAL SERVICES MEASUREMENT Collection Page No. 4/008/79 Page No. 5/008/79	
Page No. 4/008/79	
Page No. 5/008/79	
To Summary	

Preliminaries Two Bedroom Unit Look Out

				1 WO BCGICO	III OIIII LOOK Out
	A PRELIMINARIES				\$ c
	A10 PROJECT PARTICULARS				
	Title of project and postal address		(BW)		
	Look Out Two Bedroom Project; Lot 79				
Α	4840.2 square foot				
	Names and addresses of:		(BW)		
	Employer:				
В	Government of Montserrat				
	Architect:				
С	Government of Montserrat				
	Quantity Surveyor:				
D	Government of Montserrat				
	Civil Engineer:				
Е	Government of Montserrat				
	Clerk of Works:				
F	Government of Montserrat				
	A11 DRAWINGS				
	Drawings prepared by the Employer's professional advisers as follows:		(BW)		
	Drawings from which the Bills of Quantities have been prepared				
G	The units measurement have been abbreviated in the Bills as follows:- Cubice Feet - cf. Linear Feet - lf. Square Feet - sf. Number -Nr. Pound - lb	ITEM			
Н	Name: Public Works Department				
				To Collection	

Bill No. 009 / / 157 Page 2

ITEM

ITEM

ITEM

ITEM

ITEM

ITEM

To Collection

clause 3.07 Consent to sub-contracting

clause 3.09 Conditions of sub-contracting

clause 3.10 Compliance with instructions

clause 3.11 Non-compliance with instructions

clause 3.12 Instructions other than in writing

clause 3.08 List in Contract Bills

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ITEM

ITEM

To Collection

clause 8.09 Default by Employer

the Works

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Bill No. 009 / 157 Page 8

ITEM		\$ C
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ITEM		
ITEM		
	ITEM	To Collect

			<u>Preliminaries</u> <u>Two Bedroom</u>	Unit Look Out
	PERIOD OF VALIDITY as specification Tenders shall remain open for consideration (unless previously withdrawn) for not less than 90 days fro the date fixed for the submission of lodgement of tenders. Information on the date for possession/commencement can be found in sectio A20			\$ c
	Fixed charge	ITEM		
	TIME as specification Time is critical in this contrac therefore the agreed contract completion date must be adhered to			
3	Fixed charge	ITEM		
	QUERIES as specification Queries shall be raised no later than seven (7) days before the date of tenders so as to permit the circularizing of the replies to all tenderers, if this is considered necessary. Such answers as are necessary shall be given as a matter of assistance to the Tenderer but they shall not be interpreted as adding to, or taking away from, or otherwise altering the meaning and intent of the tender documents, and/or the Tenderer's obligations thereunder, which can be varied only by a letter signed by the Project Architec			
;	Fixed charge	ITEM		
	QUERIES as specification Tenderers shall refer all queries arising out of this Tender to the Project Architect whose decision for the purpose of tendering shall be final			
)	Fixed charge	ITEM		
	FLUCTUATIONS as specification No adjustments shall be made for fluctuaions in the cost of labour and materials			
	Fixed charge	ITEM		
_		L	To Collection	

			<u>Preliminaries</u> Two Bedroom U	Jnit I ook Out
			1 WO BEGIOOTI C	
	PRICING as specification Price in each item in the Bills of Quantities which is considered to have a money value. If the Tenderer omits to price any ite it will be deemed that either he/she will perform the services described free of charge or that a cost of such service has been included against items appearing elssewhere in the Bills. The rates inserte shall be deemed to be in Eastern Caribbean Currency			\$ C
4	Fixed charge	ITEM		
	PRICING as specification Prices inserted shall be deemed to include for the payment of customs and other duties, import levied and the like, for the provision of all labour, materials and plant for transport, for deliveries to Site (where not specifical mentioned in the description) for temporary storage of materials and return of empties, for the erection, maintenance and removal of scaffolding, temporary staging, plankways protection, etc. and for all other things necessary for the completion of the works in accordance with the drawings and Bills of Quantitie to the reasonable satisfaction of the Project Archite			
3	Fixed charge	ITEM		
	TEXT TO BE DEFINITIVE as specification Do not alter, add to or modify the text of the Bills of Quantities as this will not be recognized or taken int account and could lead to a disqualification of the tender. If the Contractor wishes to make an observation as to the printed text in connection to the rates he/she has inserted, such observation sha form the subject of a seperate letter to accompany his tender			
С	; fixed charge	ITEM		
			To Collection	

			<u>Preliminaries</u> <u>Two Bedroor</u>	n Unit Look Out
	Explanation of arrangement of documents as specification Technical Literature; The Contractor is advised to keep copies of the following on site, readily accessible for reference by all supervisory personnel: Manufacturer's current literature relating to all products to be used in the Works; Relevant B and or Codes of Practice			\$ C
A	BLANK	ITEM		
	Explanation of arrangement of documents as specification The Measured Quantities; For purposes of ordering products and constructing the Works: The accuracy and sufficiency of the measured quantities is not guaranteed. The specification and drawings shall take precendence over the measured quantities			
В	BLANK	ITEM		
	Explanation of arrangement of documents as specification The Specifications; All sections of the specification must be read in conjunction with Main Contract Preliminaries/General conditions			
С	BLANK	ITEM		
	Terms and symbols used as specification Approval; (and words derived thereform) means the approval in writing of the CA unless specified otherwise			
D	BLANK	ITEM		
	Terms and symbols used as specification CA; Means the person nominated in the contract as Project Architect or Contract Administrator or their authorized representative			
Е	BLANK	ITEM		
		-	To Collection	

			Preliminaries Two Bodroom I	Init Look Out
			Two Bedroom l	JIII LOOK OUL
	Terms and symbols used as specification Products; means materials (including naturally occurring materials) and goods (including components, equipment and accessories) intended for permanen incorporation in the Works.	ITEM		\$ C
	BLANK	ITEM		
,	Terms and symbols used as specification Provisional and Prime Cost (P.C.) Sums; The term "Provisional Sum" shall mean a sum provided for work or for costs which cannot be entirely foreseen, defined, or detailed at the time the tendering documents are prepared. Such sum shall be used i part or in whole as directed by the Project Architect and shall be deemed to be inclusive of any profit required by the Contractor unless otherwise indicated. The term "Prime Cost Sum" or "P.C. Su shall mean a sum provided for work or services to be executed by a sub-contractor nominated by the Project Architect, a statutory authority or a public undertaking or for materials or goods to be obtaine from a supplier nominated by the Project Architect. Such sums may be used in part or in whole as directed by the Project Architect and shall be deemed to be exclusive of any profit required by the Contractor and provision is made for the addition thereof if any. When profit is added by the Contractor the sum so added shall be adjusted in direct proportion to the amount of the P.C. sum is actually expended. Where a P.C. price is given in the description of any item of work it shall be taken as a price only for the materials or services referred to (delivered to Site, unless otherwise stated), and the Contractor shall use this price in the build-up of his/her rate for the supply and installation of that item of work. The P.C. price shall be deemed to include the Contractor's cash discount and the Contractor shall be deemed to have allowed in his price build-up for profit, overheads, attendance, etc. he/she may require for the P.C. price given. A net adjustment shall be made to the Contractor's built-up price should the service or item selected by the Architect cost more or less than the P.C. price given	ITEM		
,	BLANK	ITEM		
_			To Collection	

				Preliminarie: Two Bedroo	m Unit Look Out
	Terms and symbols used as specification Referenc Documents; where and to the extent that this specification conflicts with referenced documents, this specification prevails				\$ c
	BLANK	ITEM			
	Terms and symbols used as specification Supply And Fix; Unless stated otherwise all items given in the schedule of work and/or on the drawings are to be supplied and fixed complete				
}	BLANK	ITEM			
	A32 MANAGEMENT OF THE WORKS				
	<u>Generally</u>		(BW)		
	Management of the works as specification Maintenance or Roads; Maintain the public and private roads, footpaths, ditches,kerbs,and the like. Keep the approaches to the site free from excavate materials, mud and debris. The Contractor is to make good any damage due to any cause within his/her control at his/her own expense or pay any cost and charges in connection therewith.				
	Fixed charge	ITEM			
	Management of the works as specification Protection Of Public And Private Services; Protect, uphold, temporarily divert and maintain all pipes, ducts, drains, sewers, service mains, overhead cables and the like during the execution of the works. The Contractor is to make good any damag due to any cause within his/her control at his/her own expense or pay any cost and charges in connection therewith. Aprroval shall be obtained at least two weeks in advance if any service have to b interrupted				
)	Fixed charge	ITEM			
				To Collection	

			Preliminaries	_
			1 wo Bearoo	m Unit Look Ou
Records of climatic and other conditions as specification Adverse Weather; Use all reasonable and suitable building aids and methods to prevent o minimize delays during adverse weather conditions				\$ c
A Fixed charge	ITEM			
Records of climatic and other conditions as specification Climatic Conditions; Keep an accurate record of: Daily maximum and minimum air temperatues (including overnight). Delays due to adverse weather, including description of the weather, type(s) of work affected and number of hours lost.				
B Fixed charge	ITEM			
Control of time		(BW)		
Preparing submitting and monitoring programmes a specification Commencement Of Work; Inform the Project Architect/CA at least 5 working days before the proposed date of commencement of work on sit				
C Fixed charge	ITEM			
Preparing submitting and monitoring programmes a specification Overtime; The contractors attention is drawn to the restrcited working hours as set out under the relevant item of this Section of the Bills of Quantities. Work outside those hours specified or authorised later by the Project Architect shall be permitted				
D Fixed charge	ITEM			
			To Collection	

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		<u>Preliminaries</u>	مالمثدا متادها
		I wo Bedroom	n Unit Look Out
Preparing submitting and monitoring programmes a specification Progress Chart And Reports; 1. Weather Conditions; 2. Manpower on the job in each trade; 3. Major items of equipment on the job; 4. A brief summary of work accomplished that day; 5. Materials, equipment, or Employer furnished items arriving or leaving site; 6. Significant events, including accidents; 7. Any testing made and their results, if known; 8. Any oral instructions received; 9 Visitors on the job; 10. Possible causes for delay. The record shall show the dates of commencement and completion of all trades and parts of the work coming under the Contract. It shal also include particulars regarding daily weather conditions, excavation works, erection and removal of formwork, pouring of concrete etc., as well as the number of employees of the various trades engage on the Works.			\$ C
Fixed charge	ITEM		
Preparing submitting and monitoring programmes a specification Progress Chart And Reports; The Contractor shall prepare and submit with his/her tender a draft programme and progress chart of the entire Works. If the Contractor is awarded the Contract, he/she shall agree the details of his/her programme with the Project Architect and shall produce four (4) copies of the agreed chart on the site and record progress thereon during the execution of the Works. The Contractor shall so programme the work as not to interfere with the fre use of any existing buildings, roads, and other area and or adjoining the site. The Contractor shall keep a permanent written record on the site of the progress of the Works. This record shall be open to the inspection of the Project Architect at all reasonable times. A copy shall be furnished to the Project Architect on request. The report will contain at least the following:			
Fixed charge	ITEM		
		To Collection	

		Two Bedroo	m Unit Look O	ut
			\$ c	
ITEM				
ITEM	(BW)			
ITEM				
ITEM				
	ITEM	ITEM (BW)	ITEM (BW)	ITEM (BW)

			<u>Preliminaries</u> Two Bedroo	<u>s</u> m Unit Look Out
	Giving notice before covering up work to be measured as specification Measurement; Give reasonable notice to the Quantity Surveyor before covering up work which the Quantity Surveyor requires to be measured			\$ c
	Fixed charge	ITEM		
	Submission of daywork vouchers as specification Daywork Vouchers; Give reasonable notice to the Project Architect/CA of the commencement of any work for which daywork vouchers are to be submitted. Before being delivered, each voucher must be: 1) Referenced to the instruction under which the works is authorised, and 2) Signed by the person in charge as evidence that the workmen names, the time spent by each, the plant and materials shown are correct.			
	Fixed charge	ITEM		
	Submission of daywork vouchers as specification Interim Valuations; At least three (3) days before thend of each established Period for interim valuation submit to the QS details of amiounts due under the Contract together with all necessary supporting information			
	Fixed charge	ITEM		
	Labour and plant records as specification; At the beginning of each week provide for verification by the CA records showing, for each day of the previous week: 1) The number and description of craftsmen, labourers and other persons employed on or in connection with the Works, including those employed by subcontractors. 2) The number, type and capacity of all mechanical and power-operated plant employed on the Works.			
)	Fixed charge	ITEM		
			To Collection	

				Preliminaries Two Bedroom	<u>S</u> m Unit Look Out
	Labour and plant records as specification Fringe Benefits; Allow for all cost in respect of National Insurance, Vacation and Public Holiday Leave, Sick Leave, Cost of Living Allowances, Subsistence Allowances, travelling time and expenes and all other emoluments and expenses payable to or in connection with the employment of persons for the works. Comply with all local regulations in force relating to the welfare of the work people on the site or in places where work is being prepared for incorporation into the works and keep and maintain at all times, an adequate First Aid Kit on the site.				\$ c
Α	Fixed charge	ITEM			
	A33 QUALITY STANDARDS/CONTROL				
	Standards of materials and work Samples of products and work as specification App Throughout; Description of materials and workmanship given in any one Section of Trade are to apply throughout the Bills of Quantities unless otherwise described.		(BW)		
В	Fixed charge	ITEM			
	Samples of products and work as specification Bes Quality; Materials and workmanship are to be of the best quality of their respective kinds, and those for which there is a British Standard or Code of Practic are to confirm thereto unless otherwise stated. Workmanship must confirm to sound building practice unless otherwise described or shown.				
С	Fixed charge	ITEM			
				To Collection	

			Preliminarie Two Bedroo	<u>s</u> m Unit Look Out
			I WU DEUIUU	III OIIII LOOK OUL
	Samples of products and work as specification General Quality of Products; a) Materials and workmanship are to be of the best quality of their respective kinds and those for which there is a British Standard or Code of Practice are to confirm therto unless otherwise stated. Workmnaship is to confirm to sound building practice unless otherwise described or shown. b) Products to be new unless otherwise specified.			\$
	Fixed charge	ITEM		
	Samples of products and work as specification Goo Practice; Where and to the extent that materials, products and workmanship are not fully detailed or specified they are to be: a) Of a standard appropriate to the Works and suitable for the functions stated in or reasonable to be inferred from the project documents, b) Inaccordance with relevant good building practice.			
3	Fixed charge	ITEM		
	Samples of products and work as specification Labour Provide as Necessary; Provide as necessary, all skilled, semi-skilled and unskilled labour required for the execution and completion of the Works. Workmanship is to be of the best qualit throughout, to the reasonable satisfaction of the Project Architect. Provide a competent foreman-in-charge and all other site staff such as storekeeper, timekeeper, checker, etc., necessary for the proper supervision of the Works. Any instruction given by the Project Architect to the foreman-in-charge shall be deemed to have been given to the contractor.			
	Fixed charge	ITEM		
			To Collection	

		<u>Preliminaries</u> <u>Two Bedroom U</u>	nit Look Out
Samples of products and work as specification Labour availability; Ensure that all labour will be available for the Works and allow in the tender for the additional cost of any importation of labour from other districts that may be deemed necessary.			\$ c
Time related charge	ITEM		
Samples of products and work as specification Materials Availability; Ensure that all materials will b available from stock and, if this is not the case, make arrangements for deliveries so that no delay i occasioned due to the non-availabilty of materials.			
B Fixed charge	ITEM		
Samples of products and work as specification Materials Provide as Necessary; Provide as necessary all materials required for the proper execution and completion of the Works.			
C Fixed charge	ITEM		
Samples of products and work as specification Transportation Provide as Necessary; Provide all necessary transport for labour, materials and plant.			
D Time related charge	ITEM		
Tests and samples as specification Samples; Samples and materials, colors, finished work, etc. shall be provided, without charge to the Project Architect for approval if required. Keep approved samples on site in an approved position for use as reference by craftsmen. No materials or workmanship which in the opinion of the Project Architect is of a lower quality than the approved sample will be accepted by the Project Architect.			
E Fixed charge	ITEM		
		To Collection	

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				Preliminarie Two Bedroo	<u>s</u> om Unit Look Out
	Supervision as specification In addition to the constant management and supervision of the Work provided by the Contractor's person in charge, all significant types of works must be under the close control of competent trade supervisors to ensure maintainence of satisfactory quality and progress.				\$ c
4	Time related charge	ITEM			
	Completion/Making good defects		(BW)		
	Completing cleaning and making good the building as specification General Clear Away and Clean; Clear away all plant and temporary work unless otherwise described or directed and make good. Clear away all existing rubbish, debris and surplus materials as they accumulate and at completion. Clean floors, pavings, glass both sides and all external surfaces and leave the Works clean and perfect at completion.				
В	Time related charge	ITEM			
	A34 SECURITY/SAFETY/PROTECTION				
	Employers requirements or limitations		(BW)		
	Noise and pollution control as specification Comply generally with the Local laws as it applies to noise pollutions. Comply generally with the recommendations of BS 5228 Part 1, clause 9.3 for minimising noise levels during the execution of the Works. Take all reasonable precautions to prevent pollution on the site, the Works and the general environment.				
С	Fixed charge	ITEM			
	Water as specification Prevent damage from storm and surface water. (items for keeping the site and excavations free from water are given elsewere).				
D	Fixed charge	ITEM			
				To Collection	

		Preliminaries Two Bedroom Unit Look Ou	
Fire prevention as specification Smoking will not be permitted on the site, equip appropriate areas with fire equipment and schedule inspections to guard against risk of fire. Burning of materials arising from the work will not be permitted.			\$ C
Fixed charge	ITEM		
Nuisance as specification Take all reasonable precautions to prevent nuisance from smoke, dust, rubbish, and other causes.			
Fixed charge	ITEM		
Security as specification The site of the proposed Works shall be under the Contractor's sole charge from the date of possession to the date of completion of the Contract. Provide all necessary day and night watching to effectively protect the Works and materials stored on site including those sub-contractors and accept all risks for damage or loss. Provide all necessary temporary hoarding, barricades, planked footways, gantries, screens, etc., for the protection of the work people, occupant adjoining property and the public and alter, adapt and maintain them as necessary and clear away on completion and reinstate all work disturbed to the satisfaction of the relevant authorities.			
Time related charge	ITEM		
Protection of work as specification Protect all work including that executed by sub-contractors and specialists from any kind of injury and damage. Provide all necessary temporary roofs, tarpaulins, screens, planking and general protection that may be required and clear away when no longer needed and reinstate any work which has become damage or stained.			
Fixed charge	ITEM		
Explosive as specification DO NOT USE			
Fixed charge	ITEM		
		To Collection	

To Collection

To Collection

			Preliminaries Two Bedroom Unit Look	
includii the var includii and sto from th	as specification Provide water for the works ng that for sub-contractors and specialists, at ious levels and positions where required ng all necessary sumps temporary plumbing orage and pay all charges for drawing water he main supply. This work will be carried by mbing Contractor.			\$ c
Time	related charge	ITEM		
Provide Works and pa	one and administration as specification e a site telephone for the duration of the with branch lines to the Foreman's offices y all charges in connection therewith. This on will be made available by the Contractor.			
Time	related charge	ITEM		
comply force re work pon on site incorpo	health and welfare as specification Include foring with all local statutes and regulations in elating to the safety, health and welfare of eople employed in connection with the works or in places where work is being prepared for oration into the Works, and for keeping and ining at all times an adequate First Aid kit on e.			
Fixed	d charge	ITEM		
mainta	e of material as specification Provide and in proper sheds for the storage of materials, nd items brought on to site for use in the			
Fixed	d charge	ITEM		
removi approv time to	th disposal as specification Provide for ng all rubbish from the site and deposit in an ed dump site both as it accumalates from time and on completion, and for generally g the Works and the site clean and tidy at all			
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To Collection

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Preliminaries Two Bedroom Unit Look Out

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GOVERNMENT OF MONTSERRAT PUBLIC WORKS DEPARTMENT GENERAL CONDITIONS OF CONTRACT

GENERAL CONDITIONS

1 Definitions

- a) The "Contract" means these General Conditions together with the Specifications, drawings and includes the contract agreement
- b) The "Employer" means the Government of Montserrat
- c) The "Quantity Surveyor" means a duly authorized representative of the Employer
- d) The "Project Architect/Contract Administrator" means a duly authorized representative of the Employer
- e) The "Contractor" means the company appointed to carry out the works
- f) The "colony" means the colony of Montserrat
- g) The "Site" means the areas and/or places where on or in which the Works are to be carried out
- h) The "Works" means the works to be executed in accordance with this Contract as described in the Specifications
- i) The "language" of the Contract shall be English
- i) The "Law" applicable to the Contract, shall be the Laws of Montserrat
- k) The "Supervising Officer" means the person put in charge by the "Contractor" to supervise or oversee the work/works on site.
- 1) The "Honorable Financial Secretary" means the person with responsibility for all financial commitments for the Government of Country.

2 Contract Document - Priority

- .1 Contract Agreement
- .2 The Tender Drawings
- .3 General Conditions of Contract
- .4 Any other document forming part of the Contract

3 Extent of Contract

.1 The Contract comprises the Construction of a Two-bedroom dwelling house complete and finished as per the drawings and contract documents issued. The Tenderer is required by contract to supply all necessary labor, materials, plant and temporary works to complete the described works together with any such fixtures/fittings. The contract includes for the installation, connection and testing of all services by statutory body that may be deemed necessary to safely handover the completed works. The contractor is required to supply the Client with two sets of keys for all external doors at hand over.

4 Notices and other Communications

- .1 Any notice or other communication between the Parties, or by or to the Project Architect/Contract or Quantity Surveyor, that is expressly referred to in the Agreement or these Conditions (including, without limitation, each application, approval, consent, confirmation, counter notice, decision, instruction or other notification) shall be in writing.
- .2 Any notice or other communication and any documents to be supplied may or shall be sent or transmitted by electronic means and where expressly required by the contractor be delivered by hand. If in an emergency any communication is made orally with respect to health and safety, risk of damage to property or insurance matters, written confirmation of it shall be sent as soon as thereafter as is reasonably practicable.
- .3 Any notice or other communication referred to in clause 4.1 unless stated otherwise shall be given within 7 working days.

Notices of Discrepancy etc.

.4 If the Contractor becomes aware of any errors, omissions or inadequacy or any other discrepancy or divergence in or between the Contract Drawings; Contract Bills; any instruction issued by the Project Architect/Contract Administrator, he shall immediately give notice with appropriate details to the Project Architect/Contract Administrator; who shall issue instructions in that regard.

5 Power to Vary or Omit

- .1 The Employer reserves the right to vary from time to time during the progress of the works, the Specifications or Drawings and shall in writing, notify the Contractor of such variation. If the instructions are given orally, they shall, within **two (2)** days be confirmed in writing by the Quantity Surveyor, in the event of any such variation involving an alteration in the cost, or in the period required for completion an agreed revision of contract price and/or time of completion may be made, any such alterations should be deemed part of the Contract.
- .2 No variation, alteration or addition to the work indicated in the Specification and/or Drawing shall be made unless the written instruction of the employer has been obtained.

Exclusion of persons from the Works

.3 The Project Architect/Contract Administrator may (but shall not unreasonably or vexatiously) issue instructions requiring the exclusion from the site of any person employed thereon.

6 Assignment of Contract

- .1 Neither the Employer nor the Contractor shall without the consent of the other assign this contract or any rights thereunder.
- .2 The Contractor shall not assign the whole or any part of the Works without the consent of the Project Architect/Contract Administrator. Such consent shall not be unreasonably delayed or withheld but the Contractor shall remain wholly responsible for carrying out and completing the Works in all respects in a proper and workmanlike manner and in compliance with the Contract Documents, and other Statutory Requirements. Notwithstanding any such sub-contracting, the contractor shall give all notices required by the Statutory Requirements and remain responsible to the Employer for the

Quality and execution of all of the works including any defaults and or neglect of any sub-contractor or agent or workman employed by him.

7 Supply of Materials

.1 The Contractor shall supply all materials and goods for the works, so far as procurable, be of the kinds and standards described in the contract bills and detailed in the Specifications and on the drawings. The Contractor shall at all times be diligent and ensure that all works are executed in accordance with the laws of Montserrat.

8 Setting Out

.1 The Contractor shall be responsible for setting out of the work.

9 Workmanship

- .1 The contractor shall not substitute any materials or goods so described without the Project Architect/Contract Administrator consent, which shall not be unreasonably delayed or withheld but shall not relieve the Contractor of his other obligations. Where and to the extent that approval of the quality of materials or goods or of the standards of workmanship is a matter for the Project Architect/Contract Administrator opinion, such quality and standards shall be to his reasonable satisfaction.
- .2 To the extent that the quality of materials and goods or standards of workmanship is neither described nor stated to be a matter for such opinion or satisfaction they shall be of a standard appropriate to the works. The Contractor shall upon the request of the Project Architect/ Contract Administrator provide him with reasonable proof that the materials and goods used comply with clause 7.1.
- .3 The Employer may from time during the course of the Contract inspect any completed or part-completed work of the Contractor. If the Employer is not satisfied with such work, he shall in writing, inform the Contractor of his dissatisfaction. Notwithstanding any such progress inspection by the Project Architect/ Contract Administrator on completion of the works, the Contractor shall satisfy the Employer as to the quality and fitness of the work.

10 Removal of Debris

.1 The Contractor shall remove all debris caused by their work from time to time as it accumulates and shall leave the site clean on completion of the Contracted Works.

11 Supervision of Works and Skilled Workmen

- .1 The Contractor shall provide all necessary superintendence during the execution of the works. He shall ensure that at all times he has on the site a competent person-in-charge and any instructions given to that person by the Project Architect/ Contract Administrator shall be deemed to have been given to the Contractor.
- .2 The Contractor shall employ in and about the execution of the Works only such persons who are carefully skilled and experienced in their respective several trades. Tenderers are to provide for special attendance to include for the necessary costs in relation to the Employment of any Specialist Trades required to carry out any works related to the successful completion of the contract. This should include all travel, accommodation, and any other expense and include for their safe return at the end of the contract.
- .3 The Project Architect/ Contract Administrator may (but not unreasonably or vexatious) issue instructions requiring the exclusion from the Works of any person employed thereon.

12 Contractor's Plant

.1 The Contractor shall provide at their own cost all tools, and other plant necessary for the purpose of carrying out the specified Work in an organized and expeditious manner.

13 Payment of Fees

.1 The Contractor shall be responsible for the payment of all fees necessary for the completion of the Contract required by a Statutory Authority within or without the Colony.

14 Safety

- .1 The Contractor is responsible for the safety of all persons employed by him including his sub-contractors.
- .2 He or she shall in no way carry out any work that could be seen to endanger the life of any of his employees or of any member of the general public, including any other employee of the employer.

15 Liability of Contractor - personal injury or death

Against, any expense, liability, loss, claim or proceedings whatsoever in respect of personal injury to or death of any person arising out of or in the course of or caused by the carrying out of the Works, except to the extent that the same is due to any act or neglect of the Employer, of any of the Employer's Persons or of any Statutory Undertaker.

16 Liability of Contractor – injury or damage to property

- .1 The Contractor shall be liable for, and shall indemnify the Employer Against, any expense, liability, loss, claim or proceedings in respect of any loss, injury or damage whatsoever to any property real or personal insofar as such loss, injury or damage arises out of or in the course of or by reason of the carrying out of the Works and to the extent that the same is due to any negligence, breach of statutory duty, omission or default of the Contractor or any of the Contractor's Persons.
- .2 The reference to 'property real or personal' does not include the Works, work executed and/or Site Materials up to and including whichever is the earlier of:
 - .1 the date of issue of the Practical Completion Certificate; or
 - .2 the date of termination of the Contractor's employment.
- .3 without prejudice to his obligations to indemnify the Employer under clause 16.1 and 16.2, the Contractor shall take out and maintain insurance in respect of claims arising out of his liability in respect of claims for personal injury to or the death of any employee of the Contractor arising out of and in the course of such person's employment, shall comply with all relevant legislation;
 - .1 for all other claims to which clause 16.3 applies, shall indemnify the Employer in like manner to the Contractor (but only to the extent that the Contractor may be liable to indemnify the Employer under the terms of this contract) and shall be in a sum not less than that stated in the Contract for any one occurrence or series of occurrences arising out of one event.

17 Evidence of Insurance

.1 The Contractor shall produce such evidence as the Employer may reasonably require that the insurance's referred to herein have been taken out and are in force at all material times.

18 Traffic Control

.1 Due to the nature of the Works it will be the responsibility of the Contractor to ensure that a system of traffic control is in operation, including all signage and barriers and no vehicular access if necessary. All traffic control measures must be previously agreed with the Project Architect/ Contract Administrator.

19 Payments to the Contractor

- 1 Please note that in accordance with the GOM Financial Regulations, The Honorable Financial Secretary has advised that Contractors are to reduce their dependency on GOM taking the Risk of providing substantial Advanced Payments to them. In addition, Advanced Payment request made by Tenderers which are greater than 15% of the contracted sum will require written approval from the Honorable Financial Secretary (F.S.).
- .2 The final date for Interim Payments to the Contractor will be 14 days from its due date and after the issue of a Payment Certificate based on the value of work completed to date. A **retention of 5%** will be held from the value of each certificate up to a **maximum of 3%** of the contract sum. Such retention money will be released at the end of the rectification period provided that all works have been completed to the satisfaction of the Employer.

20 Rectification Period

.1 A warranty period of 12 months' forms part of the Contract agreement, during which time the Contractor bears the full responsibility for the execution of maintenance of the works. His responsibility should not be limited to and must include any and all repairs and or replacement of fittings/fixtures, connections and installation which malfunction or prove to be defective whether under Manufacturer's guarantee or not and any repair or correction which might become necessary due to the failure and incorrect performance of the Contractor or of his sub-contractor.

21 Handing Over Completed Works

.1 The Contractor shall **notify** the Employer in **writing** of his completion of the contracted Works. The said work shall be subject to the satisfaction of the employer and the statutory body having jurisdiction that all the works is completed and in good order. The Project Architect/ Contract Administrator shall **certify** the **date** when in his opinion, the works have reached practical completion. This date shall be the date of commencement of the **rectification period**.

Schedules of Defects and Instructions

- .1 If any defects, shrinkages or other faults in the Works or a section appear within the relevant Rectification Period due to materials, goods or workmanship not in accordance with this contract, such defects, shrinkages or other faults shall be specified by the Project Architect/ Contract Administrator in a schedule of defects, shrinkage or other faults to be made good, provided no instructions shall be issued after delivery of a schedule of defects or more than 14 days after the expiry of the relevant Rectification Period.
- .2 Within a reasonable time after receipt of such schedule or instructions, the defects, shrinkages and other faults shall at no cost to the Employer be made good by the Contractor unless the Project Architect/ Contract Administrator with the Employer's consent shall otherwise instruct. If he does so otherwise instruct, an appropriate deduction shall be made from the Contract Sum in respect of the defects, shrinkages and other faults not made good.

23 Failure to Meet Completion Date

.1 Should the contractor fail to complete the contracted works within the agreed time he shall be subject to a fine of **two thousand four hundred and fifty dollars (EC\$2450)** per day in **Liquidated Damages** for every day the completion is overdue.

24 Matters not Contained in the Contract

.1 Any matter not explicitly provided for within this Contract shall be in the matter of a separate agreement between the Employer and Contractor. Any such agreement shall be part of his Contract.

25 Matter of Disagreement/Resolution

.1 If a dispute arises under this Contract, the parties agree that they would first exhaust the provisions outlined in sections 46, 47 and 48 of the Public Finance (Management and Accountability) Procurement regulations 2012. If the parties fail to come to an amicable resolution through the provisions outlined above, then the dispute shall be settled with the help of a mutually agreed-upon mediator in Montserrat. If no resolution can still be reached, then the parties may opt for legal proceedings in the courts. The parties shall share any costs and fees equally, other than attorney fees associated with the resolution process.

26 Contract Documents

- .1 The Contractor shall receive two complete copies of Contract Documents.
- .2 Subsequent to the commencement of the Contract, the Contractor shall receive a copy of all additions to and amendments to the Specifications or drawings.

Work not in accordance with the Contract

- .1 If any work materials or goods are not in accordance with this Contract the Project Architect/ Contract Administrator, may issue instructions in regard to the removal from the site of all or any such work, materials or goods;
- .2 after consultation with the Contractor and with the agreement of the Employer, allow all or any of such work, materials or goods to remain in which event he shall notify the Contractor to that effect but that shall not be construed as a variation and an appropriate deduction shall be made from the Contract Sum.

Workmanship not in accordance with the Contract

.1 Where there is any failure to comply with clause 9 in regard to the carrying out of work in a proper and workmanlike manner the Architect/Contract Administrator, in addition, may after consultation with the Contractor, issue such instructions (whether requiring a Variation or otherwise) as are necessary. To the extent that such instructions are reasonable necessary, no addition shall be made to the Contract Sum and no extension of time shall be given.

29 Contractor Performance Report

- .1 It is a requirement of the Client for the Engineer to assess the performance of the Contractor upon Final Certificate and final payment. The assessment will be based on the following criteria;
 - i. The project deliverables achieved,
 - ii. Organization & management of works,
 - iii. Quality of work provided,
 - iv. Health & Safety plan implementation,
 - v. Management of Finances & budget,
 - vi. Technical performance & adherence to specifications,
 - vii. Completion time and scheduling.
- .2 The assessment has an overall maximum score of 1 and the following are the ratings that can be achieved;

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1.00 - 0.75 = Very Good Performance

0.74 - 0.50 = Good Performance

0.49 - 0.25 = Poor Performance

0.24 - 0.10 = Very Poor Performance
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- .3 If Contractor has attained an overall score less than 0.50 at the end of the contract performance reporting period, the Contractor will be subjected to sanctions by procuring entities.
- .4 Once a contractor has attained a first score of less than 0.50 which indicated poor performance, he/she will be sanctioned and is allowed to bid on projects that has an estimated value EC\$50,000 or less. This sanction will be implemented for 12 months.
- .5 If the Contractor has a second score on another project less than 0.50, the Contractor will be suspended from being eligible to bid on any project regardless of the value. This suspension and sanctions will run for 1 year.
- .6 After a 1-year suspension or sanction, the Contractor will be allowed to bid only on contracts valued at EC\$ 50,000 or less. If on this occasion the Contractor's score is 0.75 or greater only then will he be allowed to bid on contracts valued above EC\$50,000. If his score is less than 0.75 but is equal to or greater than 0.5, he will only be allowed to bid on contracts valued at \$50,000 or less until he can achieve a higher score.

30 Termination of the Contract

- .1 Notice of termination of the Contractor's employment shall not be given unreasonable or vexatiously.
- .2 Such termination shall take effect on receipt of the relevant notice.
- .3 Each notice referred to in this section shall be given in accordance with Clause 4.

31 Other Rights, Reinstatement

- .1 The provisions of clause 32 to 35 are without prejudice to any other rights and remedies of the Employer. The provisions of clause 37 and 39, are without prejudice to any other rights and remedies of the Contractor.
- .2 Irrespective of the grounds of termination, the Contractor's employment may at any time be reinstated if and on such terms as the Parties agree.

32 Termination by Employer

Default by Contractor

- .1 If, before practical completion of the Works, the Contractor:
 - .1 Without reasonable cause wholly or substantially suspends the carrying out of the Works or
 - .2 Fails to proceed regularly and diligently with the Works or
 - .3 Refuses or neglects to comply with a notice or instruction from the Project Architect/Supervising Officer requiring him to remove any work, materials or goods not in accordance with this contract and by such refusal or neglect the Works are materially affected; or
 - .4 Fails to comply with clause 6

The Project Architect/Supervising Officer may give to the Contractor a notice Specifying the default or defaults (the 'specified default or defaults').

.2 If the Contractor continues a specified default for 14 days from receipt of

the notice under clause 32, the Employer may on, or within 21 days from, the expiry of that 14-day period by a further notice to the Contractor terminate the Contractor's employment under this contract.

.3 If the Employer does not give the further notice referred to in clause 32.2 (whether as a result of the ending of any specified default or otherwise) but the Contractor repeats a specified default (whether previously repeated or not), then, upon or within a reasonable time after such repetition, the Employer may by notice to the Contractor terminate that employment.

33 Insolvency of Contractor

- .1 If the Contractor is insolvent, the Employer may at any time by notice to the Contractor terminate the Contractor's employment under this contract.
- .2 The Contractor shall immediately notify the employer if he makes any proposal, gives notice of any meeting or become the subject of any proceedings or appointment relating to any matters of insolvency.
- .3 As from the date the Contractor becomes Insolvent, whether or not the Employer has given such notice of termination:
 - .1 Clauses 35.3 to 35.5 and (if relevant) clause 36 shall apply as if such notice had been given;
 - .2 The Contractor's obligations under the contract and these Conditions to carry out and complete the Works shall be suspended; and
 - .3 The Employer may take reasonable measures to ensure that the site, the Works and Site Materials are adequately protected and that such Site Materials are retained on site; the Contractor shall allow and shall not hinder or delay the taking of those measures.

34 Corruption

The Employer shall be entitled by notice to the Contractor to terminate the Contractor's employment under this or any other contract with the Employer if, In relation to this or any other such contract, the Contractor or any person employed by him or acting on his behalf shall have committed an offence under the Penal Code Act of Montserrat, shall have given any fee or reward the receipt of which is an offence under Part 5 Section 78.

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35 Consequences of Termination Under Clause 32 to 34

If the Contractor's employment is terminated under clause 32, 33 or 34:

The Employer may employ and pay other persons to carry out and complete the Works and to make good any defects of the kind referred to in clause 22, and he and they may enter upon and take possession of the site and the Works and (subject to obtaining any necessary third party consents) may use all temporary buildings, plant, tools, equipment and Site materials for those purposes;

.2 the Contractor shall:

- .1 when required in writing by the Project Architect/Supervising Officer to do so (but not before) remove or procure the removal from the Works of any temporary buildings, plant, tools, equipment, goods and materials belonging to the Contractor or Contractor's Persons;
- .2 if so required by the Employer (or by the Project Architect/Contract Administrator on his behalf) within 14 days of the date of termination, assign (so far as assignable and so far as he may lawfully be required to do so) to the Employer, without charge, the benefit of any agreement for the supply of materials or goods and/or for the execution of any work for the purposes of this Contract.
- .3 no further sum shall become due to the Contractor under this Contract other than any amount that may become due to him under clause 35.5 or 36.2 and the Employer need not pay any sum that has already become due either:
 - .1 insofar as the Employer has given or gives a Pay Less Notice to specify both the sum that he considers to be due to the Contractor at the date the notice is given and the basis on which that sum has been calculated; or
 - .2 if the Contractor, after the last date upon which such notice could have been given by the Employer in respect of that sum, has become insolvent;
- .4 following the completion of the Works and the making good of defects in them (or of instructions otherwise, as referred to in clause 22), an account of the following shall within 3 months thereafter be set out in a certificate issued by the Project Architect/Contract Administrator or a statement prepared by the Employer:
 - .1 The amount of expenses properly incurred by the Employer, including those incurred pursuant to clause 35.1 and, where applicable, clause 35.3.3, and of any direct loss and/or damage caused to the Employer and for which the Contractor is liable, whether arising as a result of the termination or otherwise:

- .2 the amount of payments made to the Contractor; and
- .3 the total amount which would have been payable for the Works in accordance with this Contract;
- .5 If the sum of the amounts stated under clauses 35.4.1 and 35.4.2 exceeds the amount stated under clause 35.4.3, the difference shall be a debt payable by the Contractor to the Employer or, if that sum is less, by the Employer to the Contractor.

36 Employer's Decision not to Complete the Works

- .1 If within the period of 6 months from the date of termination of the Contractor's employment the Employer decides not to have the Works carried out and completed, he shall forthwith notify the Contractor. Within a reasonable time from the date of such notification, or if no notification is given but within that 6-month period the employer does not commence to make arrangements for such carrying out and completion, then within 2 months of the expiry of that 6-month period, the Employer shall send to the Contractor a statement setting out:
 - .1 the total value of work properly executed at the date of termination or date on which the Contractor became Insolvent, ascertained in accordance with these Conditions as if the employment had not been terminated, together with any amounts due to the Contractor under these Conditions not included in such total value; and
 - .2 the aggregate amount of any expenses properly incurred by the Employer and of any directs loss and/or damage caused to the Employer and for which the Contractor is liable, whether arising as a result of the termination or otherwise.
- .2 After taking into account amounts previously paid to the Contractor under this Contract, if the amount stated under clause 36.1.2 exceeds the amount stated under clause 36.1.1, the difference shall be debt payable by the Contractor to the Employer or, if the clause 36.1.2 amount is less, by the Employer to the Contractor.

37 Termination by Contractor

Default by Employer

.1 if the Employer;

- .1 Does not pay by the final date for payment the amount due to the Contractor in accordance with clause 19 and/or any VAT properly chargeable on that amount; or
- .2 interferes with or obstructs the issue of any certificate due under this Contract; or
- .3 fails to comply with clause 6; or

The contractor may give the Employer a notice specifying the default or defaults (the 'specified default or defaults').

- .2 If before practical completion of the Works the carrying out on a whole or substantially the whole of the uncompleted Works is suspended for a continuous period of 14 days by the reason of:
 - .1 Project Architect/Contract Administrator's instructions in respect of errors, omissions or inadequacy or any other discrepancy or divergence in or between the Contract Drawings, Contract Bills, Construction information, levels and setting out of the works, he shall immediately give notice with appropriate details to the Project Architect.
 - any impediment, prevention or default, whether by act or omission, by the Employer, Project Architect/Contract Administrator, the Quantity Surveyor or any of the Employer's persons, continues for 14 days the contractor may on, or within 21 days from, the expiry of the 14-day period by a further notice to the Employer terminate the Contractor's employment under this contract.
- .3 If the contractor for any reason does not give the further notice but the employer repeats a specified default or a specified suspension event is repeated for any period, such that the regular progress of the works is or is likely to be materially affected thereby,

then, upon or within a reasonable time after such repetition, the Contractor may by notice to the Employer terminate the Contractor's employment under this Contract.

38 Termination by Either Party

- .1 If before practical completion of the Works, the carrying out of the whole or substantially the whole of the uncompleted Works is suspended for the relevant continuous period of 14 days by reason of:
 - .1 force majeure;
 - .2 Project Architect/Contract Administrator's instructions under clause 4.4 issued as a result of the negligence or default of any Statutory Undertaker;
 - .3 loss or damage to the Works occasioned by any of the Specified Perils;

then either party, subject to clause 38.2, may upon the expiry of that relevant period of suspension give notice to the other that, unless the suspension ceases within 7 days after the date of receipt of that notice, he may terminate the Contractor's employment under this Contract. Failing such cessation within that 7-day period, he may then by further notice terminate that employment.

.2 The Contractor shall not be entitled to give notice under clause 38.1 in respect of the matter referred to in clause 38.1.3 where the loss, or damage to the Works occasioned by a Specified Peril was caused by the negligence or default of the Contractor or of any of the Contractor's Person.

39 Consequences of Termination under Clauses 37 to 38

If the Contractor's employment is terminated under clause 37 to 38

- .1 no further sums shall become due to the Contractor otherwise than in accordance with this clause 39;
- .2 the Contractor shall:
 - .1 with all reasonable dispatch remove or procure the removal from the site of any temporary buildings, plant, tools and equipment belonging to the Contractor and Contractor's Persons and, subject to the provisions of clause 39.5, all goods and materials (including site materials); and
- .3 where the Contractor's employment is terminated under clause 37 the Contractor shall as soon as reasonably practicable prepare and submit an account or, where

terminated under clause 38, the Contractor shall at the Employer's option either prepare and submit that account or, not later than 2 months after the date of termination, provide the Employer with all documents necessary for the Employer to do so, which the Employer shall do with reasonable dispatch (and in any event within 3 months of receipt of such documents). The account shall set out the amounts referred to in clauses 39.3.1 to 39.3.4 and, if applicable, clause 39.3.5, namely:

- .1 the total value of work properly executed at the date of termination of the Contractor's employment, ascertained in accordance with these Conditions as if the employment had not been terminated, together with any other amounts due to the Contractor under these conditions;
- .2 the reasonable cost of removal under clause 39.2;
- .3 the cost of materials or goods (including Site Materials) properly ordered for the Works for which the Contractor then has paid or is legally bound to pay;
- .4 any direct loss and/or damage caused to the Contractor by the termination;
- .4 the account shall include the amount, if any, referred to in clause 39.3.4 only where the Contractor's employment is terminated either:
 - .1 under clause 39 or
 - .2 under clause 38.1.3, if the loss or damage to the Works occasioned by any of the Specified Perils was caused by the negligence or default of the Employer or of any of the Employer's Persons;
- after taking into account amounts previously paid to the Contractor under this Contract, the Employer shall pay to the Contractor (or vice versa) the amount properly due in respect of the account within 28 days of its submission to the other Party, without deduction of any Retention. Payment by the Employer for any such materials and goods as are referred to in clause 39.3.3 shall be subject to such materials and goods thereupon becoming the Employer's property.

40 Variation

Definition of Variations

The term 'Variation' means;

- .1 the alteration or modification of the design, quality or quantity of the works including:
 - .1 the addition, omission or substitution of any work;
 - .2 the alteration of the kind or standard of any of the materials or goods to be used in the Works;
 - .3 the removal from the site of any work executed or Site Materials other than work, materials or goods which are not in accordance with this Contract;
- the imposition by the Employer of any obligations or restrictions in regard to the matters set out in clause 40.1.2 or the addition to or alteration of any such obligations or restrictions so imposed or imposed by the Employer in the Contract Bills or in the Employer's requirements in regard to:
 - .1 access to the site or use of any specific parts of the site;
 - .2 limitations of working space; or
 - .3 limitations of working hours;

41 Valuation of Variations and Provisional Sum Work

- .1 Subject to clause 41.2, the value of:
 - all Variations required by the Project Architect/Contract Administrator's instructions or subsequently sanctioned by him in writing;

- .2 all work which under these conditions is to be treated as a Variation;
- .3 all work executed by the Contractor in accordance with Project Architect/Contract Administrator's instructions as to the expenditure of Provisional Sums included in the Contract Bills or in the Employers Requirements;

shall be such amount as is agreed by the Employer and the Contractor or, where not agreed, shall, unless otherwise agreed by the Employer and the Contractor, be the amount valued by the Quantity Surveyor (a 'Valuation') in accordance with clause 44 ('the Valuation Rules').

.2 Clause 41.1 shall not apply in respect of a Variation for which a Variation Quotation is made and for which the Project Architect/Contract Administrator issues a Confirmed Acceptance or in respect of a Variation thereto to which clause 42.3 applies

42 Variation Quotation

- .1 If the Project Architect/Contract Administrator in his instructions for a Variation states that the Contractor is to provide a quotation (a Variation Quotation), the Contractor shall subject to receipt of sufficient information provide a quotation in accordance with those provisions, unless within 7 days of his receipt of that instruction (or such longer period as is either stated in the instruction or agreed between them) he notifies the Project Architect/Contract Administrator that he disagrees with the application of the procedure to that instruction.
- .2 If he Contractor notifies his disagreement within that period, he shall not be obliged to provide that quotation and the Variation shall not be carried out unless and until the Project Architect/Contract Administrator gives a further instruction that the Variation is to be carried out and is to be valued by a Valuation.
- .3 Where a Variation Quotation has been made for work and a Confirmed Acceptance issued, then, if the Project Architect/Contract Administrator subsequently issues an instruction requiring a Variation of that work, the Quantity Surveyor shall make a valuation of that Variation on a fair and reasonable basis having regard to the content of that quotation and shall include in that valuation the direct loss and/or expense, if any, incurred by the Contractor because the regular progress of the Works or of any part of them is materially affected by compliance with the instruction.

43 Contractor's right to be Present at Measurement

- .1 Where it is necessary to measure work for the purpose of a Valuation the Quantity Surveyor shall give the Contractor an opportunity to be present at the time of such measurement and to take such notes and measurements as the Contractor may require.
- .2 Effect shall be given by means of addition to or deduction from the Contract Sum to each agreement by the Employer and the Contractor under clause 41.1 each Valuation, each Confirmed Acceptance and each valuation under clause 42.3.

44 The Valuation Rules

Measurable Work

- .1 To the extent that a Valuation relates to the execution of additional or substituted work which can be valued by measurement or to the execution of work for which an Approximate Quantity is included in the Contract Bills, such work shall be measured and shall be valued in accordance with the following rules:
 - .1 where the additional or substituted work is of similar character to, is executed under similar conditions as, and does not significantly change the quality of, work set out in the Contract Bills, the rates and prices for the work so set out shall determine the valuation;
 - .2 where the additional or substituted work is of similar character to work set out in the Contract Bills but is not executed under similar conditions there to and/or significantly changes its quantity, the rates and prices for the work so set out shall be the basis for determining the valuation and the Valuation shall include a fair allowance for such difference in conditions and/or quantity;
 - .3 where the additional or substituted work is of similar character to work set out in the Contract Bills, the work shall be valued at fair rates and prices;
- .2 In any valuation of work under clause 44.1
 - .1 Measurement shall be in accordance with the same principles as

- those governing the preparation of the Contract Bills;
- allowance shall be made for any percentage or lump sum adjustments in the Contract Bills; and
- .3 allowance, where appropriate, shall be made for any addition to or reduction of preliminary items of the type referred to in the Standard Method of Measurement, provided that no such allowance shall be made in respect of compliance with a Project Architect/Contract Administrator's instruction for the expenditure of a Provisional Sum for defined work.

GOVERNMENT OF MONTSERRAT

TENDER SUBMISSION ANTI-COLLUSION CERTIFICATE

I/WE CERTIFY THAT THIS TENDER IS MADE IN GOOD FAITH, AND THAT WE HAVE NOT FIXED OR ADJUSTED THE AMOUNT OF THE TENDER BY OR UNDER OR IN ACCORDANCE WITH ANY AGREEMENT OR ARRANGEMENT WITH ANY OTHER PERSON. I/WE ALSO CERTIFY THAT WE HAVE NOT AND I/WE UNDERTAKE THAT WE WILL NOT BEFORE THE AWARD OF ANY CONTRACT FOR THE WORK:

DISCLOSE THE TENDER PRICE OR ANY OTHER FIGURES OR OTHER INFORMATION IN CONNECTION WITH THE TENDER TO ANY OTHER PARTY (INCLUDING ANY OTHER COMPANY OR PART OF A COMPANY FORMING PART OF A GROUP OF COMPANIES OF WHICH I AM/WE ARE A PART OF) NOR TO ANY SUB-CONTRACTOR (WHETHER NOMINATED OR DOMESTIC) NOR SUPPLIER (WHETHER NOMINATED OR DOMESTIC) OR ANY OTHER PERSON TO WHOM SUCH DISCLOSURE COULD HAVE THE EFFECT OF PREVENTING OR RESTRICTING FULL COMPETITION IN THIS TENDERING EXERCISE

ENTER INTO ANY AGREEMENT OR ARRANGEMENT WITH ANY PERSON THAT THEY SHALL REFRAIN FROM TENDERING, THAT THEY SHALL WITHDRAW ANY TENDER ONCE OFFERED OR VARY THE AMOUNT OF ANY TENDER TO BE SUBMITTED OR OTHERWISE COLLUDE WITH ANY PERSON WITH THE INTENT OF PREVENTING OR RESTRICTING FULL COMPETITION

PAY, GIVE OR OFFER PAY OR GIVE ANY SUM OF MONEY OR OTHER VALUABLE CONSIDERATION DIRECTLY OR INDIRECTLY TO ANY PERSON FOR DOING OR HAVING DONE OR CAUSING OR HAVING CAUSED TO BE DONE IN RELATION TO ANOTHER TENDER OR PROPOSED TENDER FOR THE WORK ANY ACT OR THING OF THE SORT DESCRIBED AT I), II) OR III) ABOVE.

I/WE FURTHER DECLARE THAT I/WE HAVE NO KNOWLEDGE EITHER OF ANY SUM QUOTED OR OF ANY OTHER PARTICULARS OF ANY OTHER TENDER FOR THIS CONTRACT BY ANY OTHER PARTY.

I/WE FURTHER CERTIFY THAT THE PRINCIPLES DESCRIBED ABOVE HAVE BEEN, OR WILL BE, BROUGHT TO THE ATTENTION OF ALL SUB-CONTRACTORS, SUPPLIERS AND ASSOCIATED COMPANIES PROVIDING SERVICES OR MATERIALS CONNECTED WITH THE TENDER AND ANY CONTRACT ENTERED INTO WITH SUCH SUB-CONTRACTORS, SUPPLIERS OR ASSOCIATED COMPANIES WILL BE MADE ON THE BASIS OF COMPLIANCE WITH THE ABOVE PRINCIPLES BY ALL PARTIES.

I/WE ACKNOWLEDGE THAT ANY BREACH OF THE FOREGOING PROVISIONS SHALL LEAD AUTOMATICALLY TO THIS TENDER BEING DISQUALIFIED AND MAY LEAD TO CRIMINAL OR CIVIL PROCEEDINGS. THE GOVERNMENT OF MONTSERRAT SHALL TREAT ANY TENDER RECEIVED IN CONFIDENCE BUT RESERVES THE RIGHT TO MAKE THE SAME AVAILABLE TO ANY OTHER FUNDING ORGANISATION OR STATUTORY REGULATORY AUTHORITY EITHER HAVING JURISDICTION OVER THE WORKS OR WHO MAY NOW OR AT ANY TIME IN THE FUTURE HAVE STATUTORY POWER TO REQUIRE DISCLOSURE OF THIS TENDER.

IN THIS CERTIFICATE, THE WORD 'PERSON' INCLUDES ANY PERSONS AND ANY BODY OR ASSOCIATION, INCORPORATED OR UNINCORPORATED; ANY AGREEMENT OR ARRANGEMENT INCLUDES ANY TRANSACTIONS, FORMAL OR INFORMAL AND WHETHER LEGALLY BINDING OR NOT; AND 'THE WORK' MEANS THE WORK IN RELATION TO WHICH THIS TENDER IS MADE.

SIGNATURE	IN THE CAPACITY OF
Date	2017
DULY AUTHORISED TO SIGN TEND FOR AND ON BEHALF OF:	DERS AND ACKNOWLEDGE THE CONTENTS OF THE ANTI-COLLUSION CERTIFICAT
Name of Firm	
FULL POSTAL ADDRESS	
TELEPHONE NO	Fax No

EVALUATION OF TENDER

Evaluation Criteria

The following evaluation criteria will be used to evaluate tenderers submissions received in response to the Invitation to Tender delivered. The Administrative Compliance would be applied before the remaining criteria and is either a pass or fail, with failure meaning that bids would be deemed Non-compliant. Please note that any bids deemed Non-compliant will not be evaluated.

Criteria Description	Weight (%)
Administrative Compliance	Pass / Fail
Method Statement / Risk Assessment	15
Programme of Works	20
Financial Compliance	40
Technical Compliance & Tenderer's Experience	25

Administrative Compliance (Pass/Fail)

Tenderers must submit all the documents requested in the tender pack document. The tender checklist provides a list of requirements which need to be fulfilled. All Tenderers are required to fully complete the Form of Tender including the commencement time and the proposed completion time which are highlighted. In addition, Tenderers are required to fully complete the Bill of Quantities and Schedules A - D provided. A valid Tax Compliance Certificate must be submitted with each submission (if tenderer locally based). Tenderers must sign and date the Anti-Collusion statement. In addition, details of two (2) previous works of similar nature must be submitted in accordance with the Technical Compliance requirements. Submission of these fulfils The Administrative Compliance which is weighted a Pass/Fail. Where <u>all</u> the above requirements have been fulfilled then the tenderer would advance to the subsequent evaluation criteria. If any of the above mentioned items are not submitted, then the tender would be deemed **non-compliant** and the submission rejected.

Method Statement and Risk Assessment (15%)

Tenderers are required to submit a Method Statement to be used to help manage the work and ensure that the necessary precautions have been communicated to all parties so the wellbeing of the workforce is not affected. This will be a means of controlling specific Health and Safety risks identified, (example: noise and dust pollution; protection for site personnel, equipment, and the general public). Tenderers should provide a fully detailed outline of the work task or process which should be completed in carrying out the said works. Risk control strategies and procedures should also be identified to ensure that all the significant Health and Safety risks can be lessened. Tenderers should also submit a risk method statement to show who is responsible and how to eliminate (or reduce as far as possible) the possibility of an accident occurring where individuals may suffer injury or work related illness, or where property may be damaged. Ensuring Health and Safety of all throughout the works is paramount to the project's success. This criterion would be assessed by a 15% weighting.

Programme of Works (20%)

Tenderers are required to provide a comprehensive programme of works showing a list of all activities which would be carried out to supply, construct and deliver all the works complete. The programme should effectively show start, duration and end dates of each activity including delivery dates of key materials. All programmes must show dates for testing, commissioning and connection of MUL services and the total duration for completing the works including the date of hand over of keys. Programmes with the necessary requirements would be assessed by obtaining a percentage out of 20%. Please note that time is key to this projects success therefore programmes should reflect the time stated in the Form of Tender.

Financial Compliance (40%)

The tendered price is a significant component and the Government of Montserrat will seek to ensure that the works are undertaken at the **Most Economically Advantageous Tendered Price**. Nonetheless, the Government of Montserrat is not bound to accept the lowest or any tender.

The percentage for this criterion will be calculated proportionately in comparison to other priced submissions from tenderers, and assessed by obtaining a required percentage weighting out of (40%).

The **Hon F.S.** has advised that Contractors are to reduce their dependency on GOM taking the **Risk** of providing substantial Advanced Payments to them. In addition, consideration with strong supporting evidence will be required for all Advanced payment request Contractors put in their Payment Schedules of more than **15%**.

Except in cases where there is an exemption from tax, of which proof must be provided; residents of Montserrat for tax purposes are subject to tax on the profits from this project while non-residents are liable to a 20% Withholding Tax deduction from the gross amount.

Please take into consideration your tax obligations and liabilities to the Government of Montserrat. For further information please contact Montserrat Customs & Revenue Service (MCRS) via email at irev@gov.ms

Technical Compliance and Experience (25%)

Adherence to the technical specification is paramount to tenderers achieving success in the evaluation process. Prospective tenderers need to provide details of at least 2 previous contracts completed within the past 5 years of a similar nature to the scope of works of this tender with a value of a minimum \$450,000.00 for material and labour and a minimum value of \$180,000 for labour only. These details should include but are not limited to the following; the entity or person for which the work was completed, contact information for the entity or person, the value of the works, the location of the works. In addition, the prospective tenders can submit award letters for works in lieu of the above mentioned information. The percentage for this criterion will be calculated proportionately in comparison to other submissions from tenders and assessed on a weighting of (25%).

Start Date or Date of Award	Description of Works	Name of Client	Price of Contract	Date Completed



Ministry of Communication, Works & Labour

MOH Public Works Department PWD17/1	M Contract Ref			Department		Document Ref	
elivery Point / Project Location OH HQ, Brades OH HQ, Brades OH HQ, Brades Project Sessing Officer Project Objective Scope Scope Scope OL Deliverables OL De	ОН			Public Works Department		PWD17	'/18-0 <i>'</i>
Project & Contract Title	rvice/Item Code			Contractor & VDB No (if known)			
The Construction of Two Bedroom Unit" at Look Out, Lot157	rastructure Contractor Service						
Project Dijective	livery Point / Project Location			Project & Contract Title			
Scope	OH HQ, Brades			"The Construction of Two Bedroom l	Jnit" at <mark>Look O</mark>	ut, Lot157	
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Tilling			_				
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External Works			_				
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Architect's Inspection (Quality) 1 2 Architect's Inspection (Quality) 0 NA		1		Meets Drawing Specifications	0	NA	
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PROJECT CLOSE OUT REPORT	ogramme i ime (weeks)					I NA	

SCHEDULE A: LABOUR RATES

I (We) hereby certify that to the best of my (our) knowledge and belief the wages, hours of work, and conditions of labor of all work people proposed to be employed by me (us) on this project for which I (we) am (are) offering myself (ourselves) as a Contractor are fair and reasonable having regard to the statutory provisions regulating rates of wages as are in force in Montserrat on the date of this my (our) Tender and I (we) will accept responsibility for the observance of these regulations by sub-contractors employed by me (us) in the execution of the works.

The Tenderer shall list the labor, by classification, which he proposes to have on the site for performing all of the work, together with the applicable hourly rates. The rates stated for wages and hours of work as listed below shall include all fringe benefits, overhead and profit.

Class of Work-person	Rates of Wages (*) \$/hr.	Hours of Work (**)
Foreman		
Mason		
Carpenter		
Steel bender/fixer		
Skilled Laborer		
Laborer		
Electrician		
Tiler		
Machine Operator		

excess of hours per work day and Saturdays and rates of wages for work on Sunday and Statutory Holidays.	times the above
* per hour** In a normal working day	
Dated this day of 2017	
(Signature) Letters)	(Name in Block
being an officer of, and duly authorized to sign on behalf of	
Address)	(Business
(Telephone)	

I (We) shall pay times the above rates of wages for normal overtime work in

SCHEDULE B: CONSTRUCTION MATERIALS

On the following page(s) I (We) have listed to the best of my (our) knowledge all of the required construction materials to be incorporated into the permanent Works, together with the names of my (our) proposed suppliers and the unit for each material including the country of origin thereof if not locally sourced.

We have satisfied ourselves that the suppliers' delivery schedules are realistic and/or we have satisfied ourselves that materials are available in sufficient quantities to execute the works without delay, and that materials conform with all requirements of the Specification.

We understand that all materials will be subject to inspection and tests by the Project Architect/Contract Administrator.

Material	Supplier	Unit Cost (EC\$)
Sand		
Aggregate		
Cement		
Reinforcement #3 – 3/8"		
Reinforcement #4 – ½"		
Reinforcement #5 – 5/8"		
Reinforcement #6 – 3/4"		
Reinforcement #7 – 1/8"		
Reinforcement #8 – 1"		
Reinforcement #10 BRC welded		
mesh, 2.9 grade 6mm		
Form Ply - ½" and ¾"		
Truss straps		
Lumber		
Threaded bolts, nuts, washers		
Asphalt Roof shingles		
Concrete screws		
Paint		
Conduit		
Earth rod and clamps		
Switches		
Main switches		
Luminaries and lamps		
Electrical wire		
Lamp holders		
Outlets 110, 240		
Wardrobe unit		
Counters		
Kitchen cabinets		
Kitchen sink		
WC Toilet		
Face Basin		
Basin Mixer (Faucet)		

Bathroom vanity unit		
Wall fixed shower		
Toilet roll holder		
Towel Rail		
Shower Curtain Rod		
Mirror		
Shower mixer roughing valve and		
trim		
Laundry sink		
Laundry sink mixer		
External Doors		
Internal Doors		
Lever handle and Privacy		
Locking function		
Hinges		
Aluminum doors		
Windows (sliding sash)		
Anti-slip tiles		
Grout		
·	·	

Dated this day of 2017	
(Signature) Letters)	(Name in Block
being an officer of, and duly authorized to sign on behalf of	
Address)	(Business
(Telephone)	

SCHEDULE C: CONSTRUCTION EQUIPMENT

I (We) propose to employ the following construction machinery and equipment for the execution of the Works and to the best of my (our) knowledge, the equipment listed is in sufficient capacity to construct all of the Works within the time specified for completion.

Note: Indicate (*) if equipment is to be rented or sub-contracted locally, and provide details. Also list the rate of hourly hire of all equipment for Day-work purposes. Do not list hand tools or normal tools required by trade persons.

Description of Equipment	Hourly Rate for Day-work (EC\$)
Concrete Mixer (with hopper)	
Concrete Mixer (without hopper)	
5 Ton Lorry	
3 Ton Lorry	
Vibrator	
Backhoe	
Bobcat	
Excavator	
Vibrator	
Tele-hoist	

Dated this day of 2017
(Name in Block Letters)
being an officer of, and duly authorized to sign on behalf of
(Business Address)
(Telephone)

SCHEDULE D: LIST OF PROPOSED ESTABLISH SUB-CONTRACTORS

I (We) propose to sub-contract the following parts of the Works to the sub-contractors listed below. I (We) agree not to make changes to this list without the written consent of the Project Architect/Contract Administrator.

In my (our) opinion, the sub-contractors named hereunder are reliable and competent to perform that part of the works for which each is listed and, in any case, I (we) understand that all proposed sub-contractors shall be subject to the Project Architect/Contract Administrator's written approval.

Name and Address of Sub-Contractor	Part of the Works
	Steel Bender/Fitter
	Electrician
	Carpenter
	Mason
	Painter
	Landscaping
	Labor
	Plumber

Dated this day of 2017	
(Name in Block Letters) (Signature)	
being an officer of, and duly authorized to sign on behalf of	
(Business Address)	
(Telephone)	

Minimum Outline Specification:

Kitchen Cabinets:

Option I: Prefabricated face frame modules complete with doors, drawers,

internal fittings and hardware but excluding handles from

approved supplier

Option II: Treated pine face framed plywood carcasse built in place with

standard raised panel doors & drawer fronts. Cabinets shall have edge-lipped fixed internal shelving. Hardware shall be Euro-type concealed hinges for doors and ball bearing slides for drawers

Counters:

12mm solid acrylic resin countertop with 40mm milled bullnose downstand edge profile @ front and 100mm upstand backsplash @ wall junction. Counter fabricator shall template as-built carcasse prior to fabrication. All joints shall be flush and invisible.

Wardrobe Unit:

Option I: Free standing face frame modules complete with doors, drawers, accessories & hanging rails from approved supplier

Option II: Treated pine face framed plywood carcasse built in place with standard full louvre doors or similar & approved.

Cabinets shall have a fixed internal shelf @ 6'-0"AFF and continuous

hanging rail @ 5'-6"AFF.

WC:

Option I: White porcelain close coupled English 'P' trap toilet with water saving dual flush feature. Toilet shall be supplied complete with seat. Toilet shall be supplied with ¼" turn shut-off angle valve, rose, flex line, pan connector and all necessary accessories for full installation into the Works

Option II: White porcelain close coupled 'S' trap toilet with water saving feature. Toilet shall be supplied complete with seat. Toilet shall be supplied with 1/4" turn shut-off angle valve, rose, flex line, wax ring, floor fixing brackets and all necessary accessories for full installation into the Works

Face Basin:

Single hole drop-in basin finished in white porcelain and with overflow. Face basin shall be supplied with standard 1 1/4" plastic trap and all necessary accessories for complete installation into the Works

Basin Mixer (Faucet):

Single lever pillar type mixer tap manufactured from solid brass and having ¼ turn disc valve technology. Finish shall be standard chrome over brass. The mixer should include slotted waste and shall be supplied with flexi hose pipes, angle shut-off valves and all necessary fixing to complete the installation

Shower mixer (Roughing valve & Trim):

Roughing-in valve shall be brass bodied, single outlet (non-diverter) type with standard ½" NPT threading. Cartridge shall be ¼ turn ceramic type. Trim shall be single lever with rose

Accessories:

Towel bar, loo roll holder and wall-fix soap shelf of reasonable quality shall be suppled complete with wall fixings suitable for masonry construction

Mirror:

Appx. 24" wide x 30" tall complete with frame compatible for use in damp areas

Kitchen Sink:

Single bowl, 3-hole stainless steel sink with typical dimensions of 25" wide, 22" deep and having a bowl depth of 10"

Bathroom Vanity Unit:

Option I: Prefabricated face frame module complete with doors, and

hardware but excluding handles from approved supplier

Option II: Treated pine face framed plywood carcasse built in place with

standard raised panel doors. Hardware shall be Euro-type

concealed hinges for doors.

Laundry Sink:

24" plastic Laundry tub complete with legs.

Laundry Sink mixer:

4" spread deck mount. Lever operation preferred as these types are more ergonomic (especially for those with physical disabilities). The neck of the faucet shall have movement through 180 degrees. Finish shall be chrome over solid brass

Internal Doors:

Veneered 1 3/8" thick solid core flush OR raised panel formed of stock hardwood timbers

External Doors:

1 ½" minimum thickness fiberglass OR aluminium. 1 5/8" minimum thickness hardwood is also acceptable

Windows:

Description: Double hung sliding sash with tilt opening feature (for cleaning convenience) complete with locking hardware and insect screens. Units shall be supplied with clear or tinted glass and without dividing lites.

Details: Frame and sash members shall be welded 100% virgin uPVC extrusions and reinforced with aluminium, zinc plated steel or other corrosion resistance material compatible with rigid PVC. Hardware:

Lock & Keeper: Painted cast zinc sweep lock and keeper. Sash Release Tilt Mechanisms: High impact nylon housing and latch units

Tilt Pivot Bar: Zinc plated steel with high strength and rigidity. Weather Stripping: Silicone treated pile with a polypropylene center fin. Closed cell bulb weather seal.

Insect screens: Removable for cleaning

Locks & Cylinders:

External doors:

Description: Keyed single cylinder lever with internal thumb turn

Details: Locks shall be fully reversible, have concealed screws for both interior and exterior levers, having stainless internals and shall feature a manufacturer's warranty of at least 10 years on both mechanical and finish performance.

Bedroom & Bathroom:

Lever handle with privacy locking function

Hinges:

Stainless steel ball bearing butts:

External doors shall be 4"x4" (1.5 pairs)

Internal doors shall be 3"x3" (1.5 pairs)

Shutter hinges shall be 3"x3" (1.5 pairs)

Roofing	china	1000
KUUIIIII	3111119	ıcs.

Asphalt roofing shingles with algae/fungal resistant coating

Structural Timbers:

Framing timbers shall be kiln dried and pressure treated against decay and insect attack. Timbers shall be certified structural grade

Decorative Coatings:

Internal walls: Washable satin emulsion over masonry primer

External walls: Trowel applied latex based finish with anti-fungal additive such as

Trowel Plastic or <u>similar</u> and <u>approved</u>

Exposed framing timbers & door frames: Satin finish oil paint over primer. Primer shall be the popular 'gripper' type of primer that


provides for proper adhesion of the top coat


Built-in cabinetry: Water based interior stain formulations designed for rag or bristle

brush application. No gel types

Tiles: External and wet areas require anti-slip performance

* * * * * * * * * END OF SPECIFICATION * * * * * * * * *

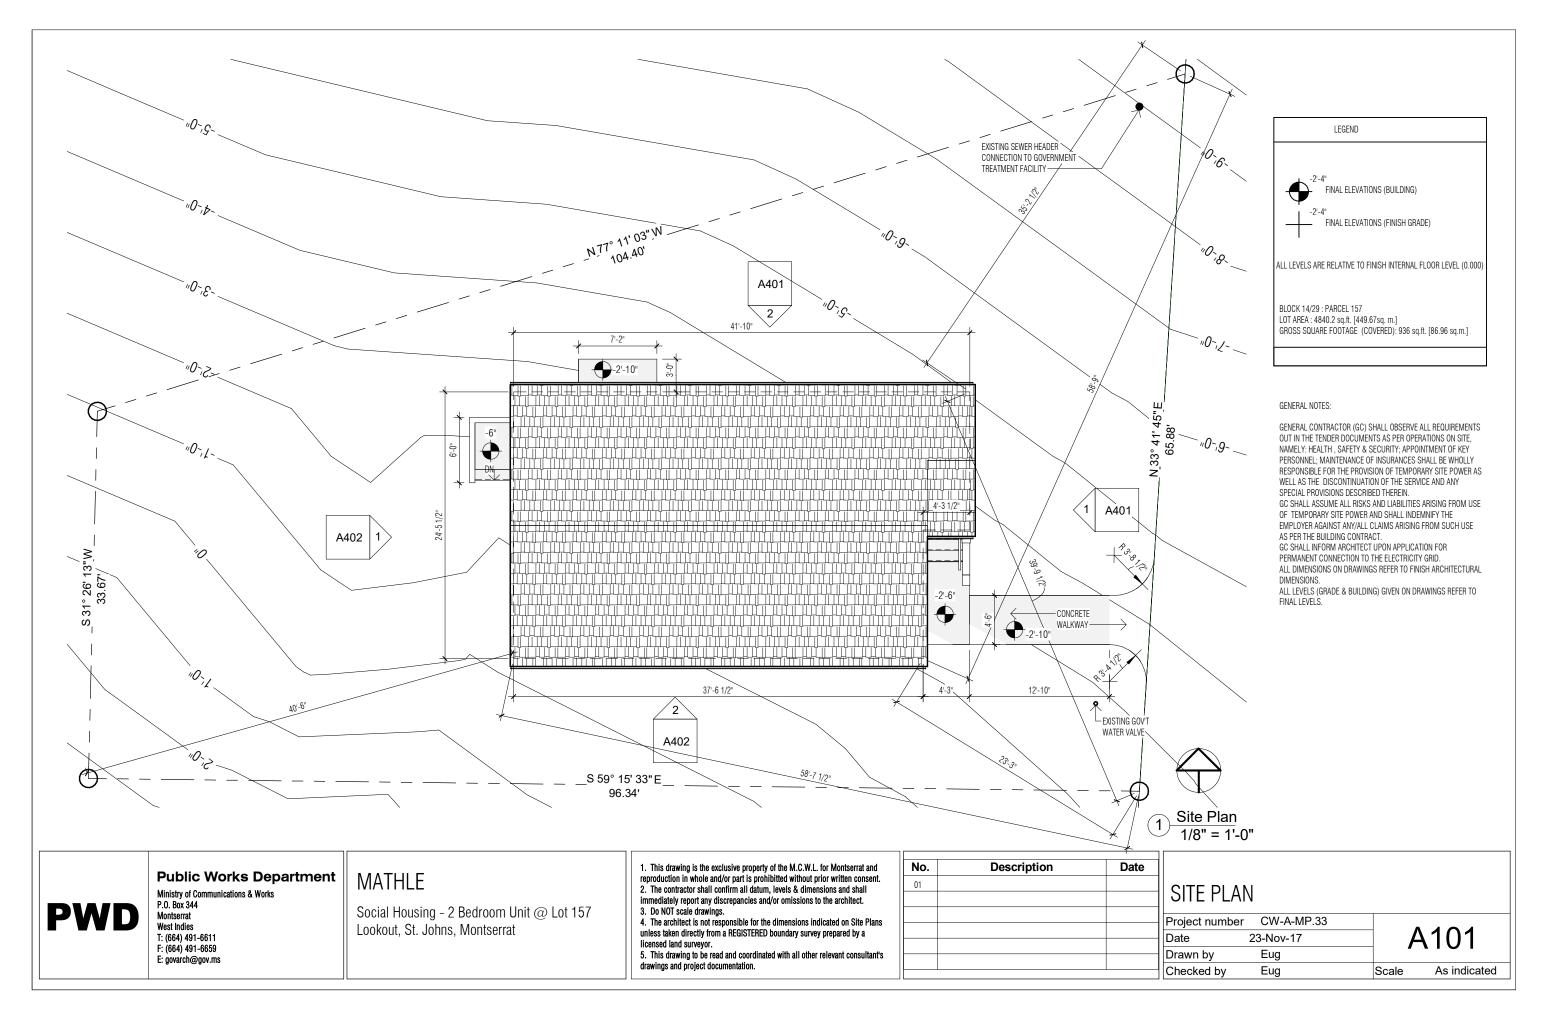

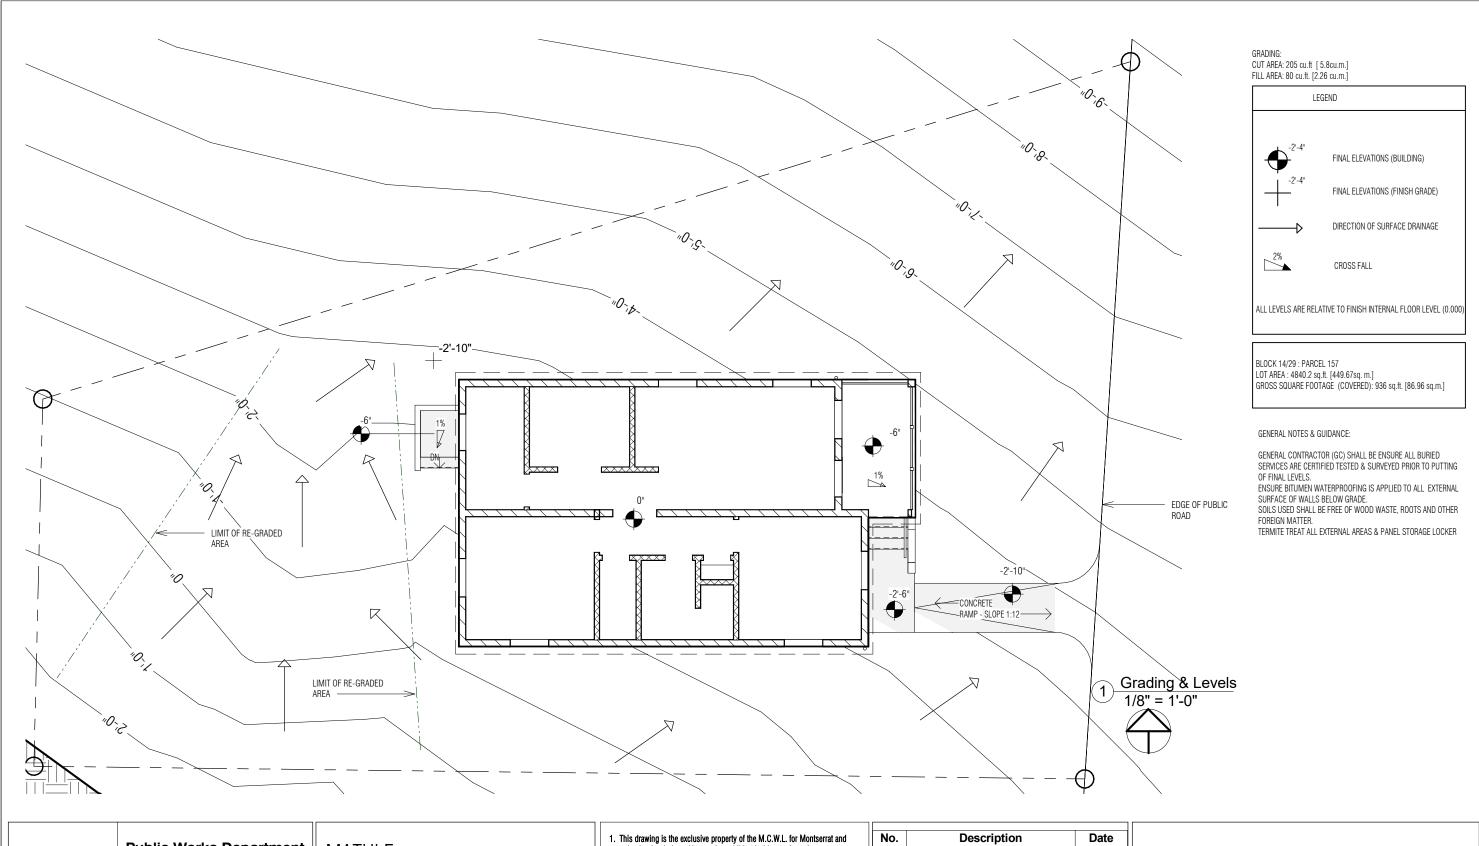



Public Works Department

Ministry of Communications & Works P.O. Box 344
Montserrat
West Indies
T: (664) 491-6611
F: (664) 491-6659
E: govarch@gov.ms

MATHLE


Social Housing - 2 Bedroom Unit @ Lot 157 Lookout, St. Johns, Montserrat

- This drawing is the exclusive property of the M.C.W.L. for Montserrat and reproduction in whole and/or part is prohibitted without prior written consent.
 The contractor shall confirm all datum, levels & dimensions and shall immediately report any discrepancies and/or omissions to the architect.
 Do NOT scale drawings.
- The architect is not responsible for the dimensions indicated on Site Plans unless taken directly from a REGISTERED boundary survey prepared by a licensed land surveyor.
- This drawing to be read and coordinated with all other relevant consultant's drawings and project documentation.

No.	Description	Date

FINAL GRADING & DRAINAGE

	014/ 4 445 00			
Project number CW-A-MP.33				
Date	23-Nov-17		□ A102	
Drawn by	Eug		•	
Checked by	Eug		Scale	As indicated

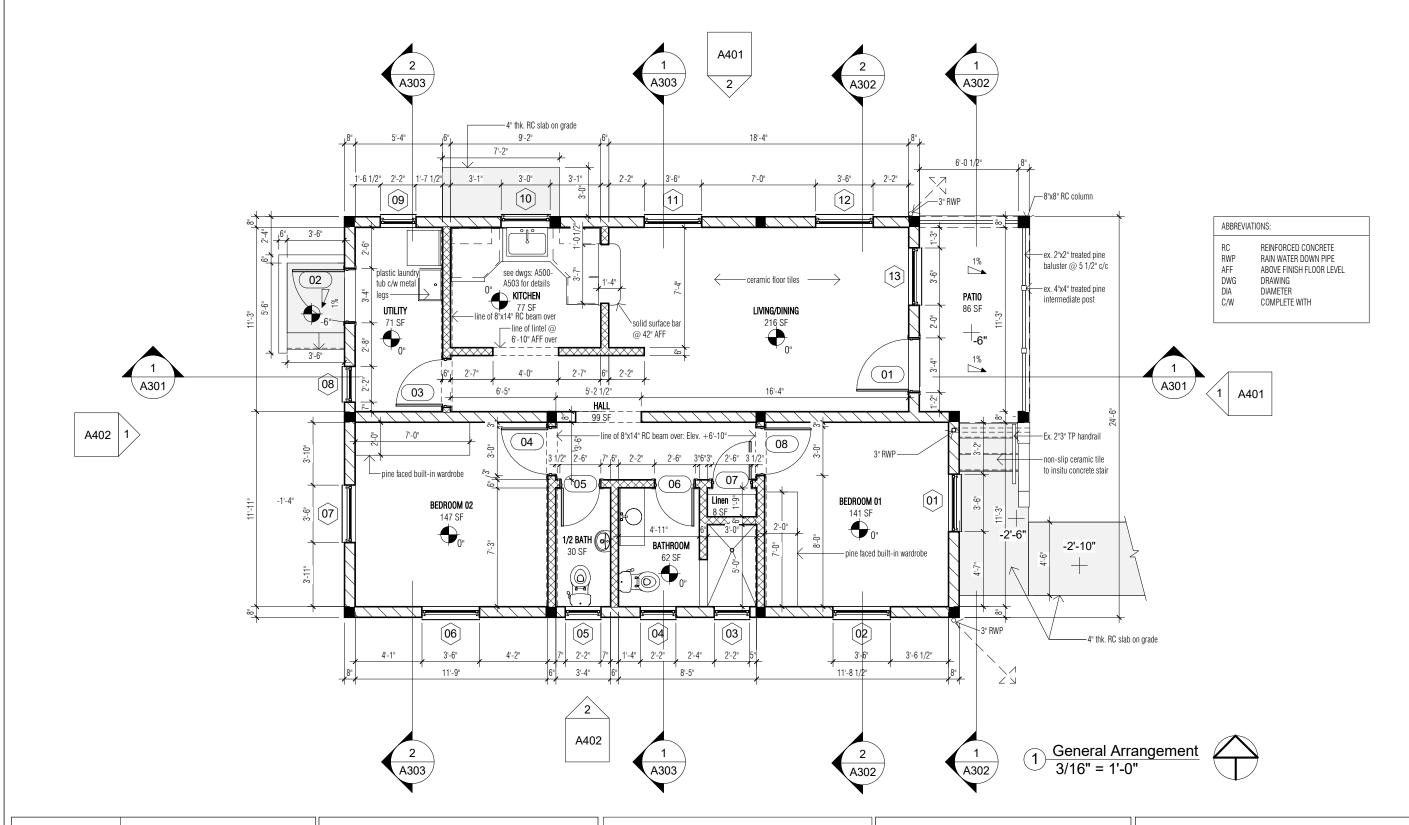



Public Works Department

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West Indies
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MATHLE


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 The architect is not responsible for the dimensions indicated on Site Plans unless taken directly from a REGISTERED boundary survey prepared by a licensed land surveyor.
- 5. This drawing to be read and coordinated with all other relevant consultant's drawings and project documentation.

Description	Date
	Description

GENERAL ARRANGEMENT

	Project number	CW-A-MP.33		
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	rawn by	Eug		
	Checked by	Eug	Scale	3/16" = 1'-0"

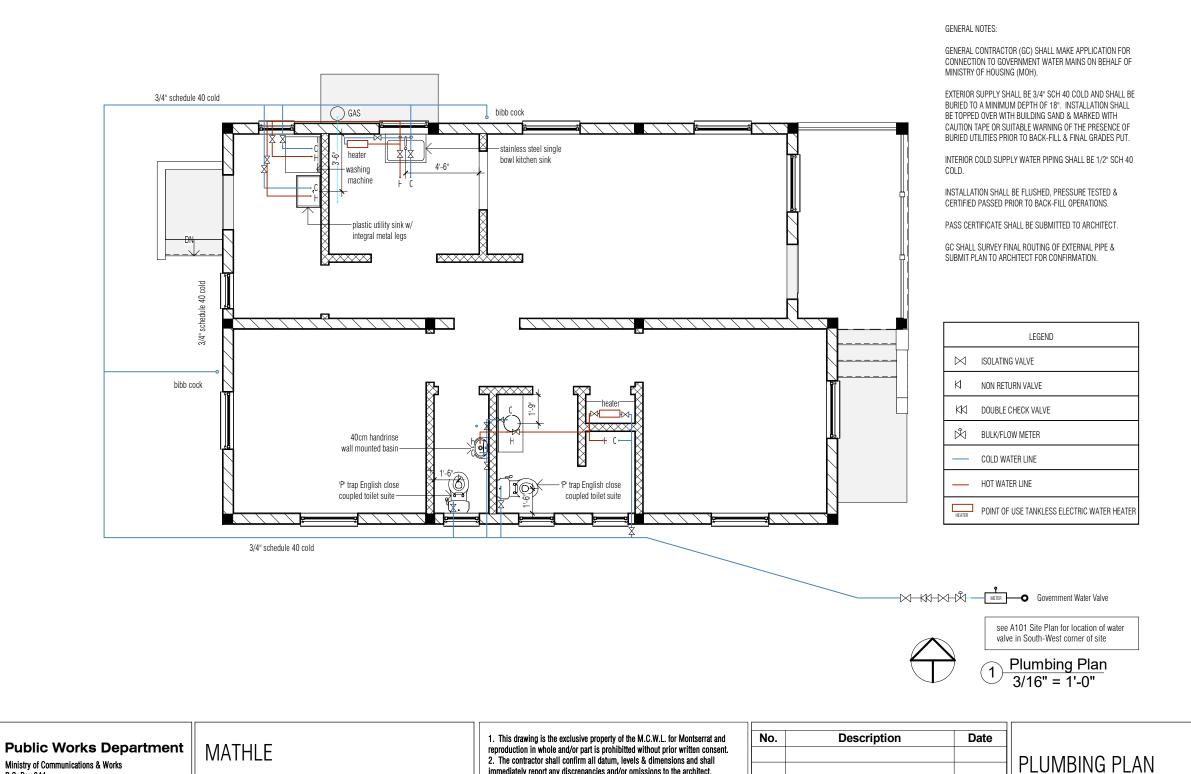

immediately report any discrepancies and/or omissions to the architect.

unless taken directly from a REGISTERED boundary survey prepared by a

4. The architect is not responsible for the dimensions indicated on Site Plans

This drawing to be read and coordinated with all other relevant consultant's drawings and project documentation.

3. Do NOT scale drawings.

licensed land surveyor.

Social Housing - 2 Bedroom Unit @ Lot 157

Lookout, St. Johns, Montserrat

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E: govarch@gov.ms

PWD

3/16" = 1'-0"

A202

Project number CW-A-MP.33

Date


Drawn by

Checked by

23-Nov-17

Eug

Eug

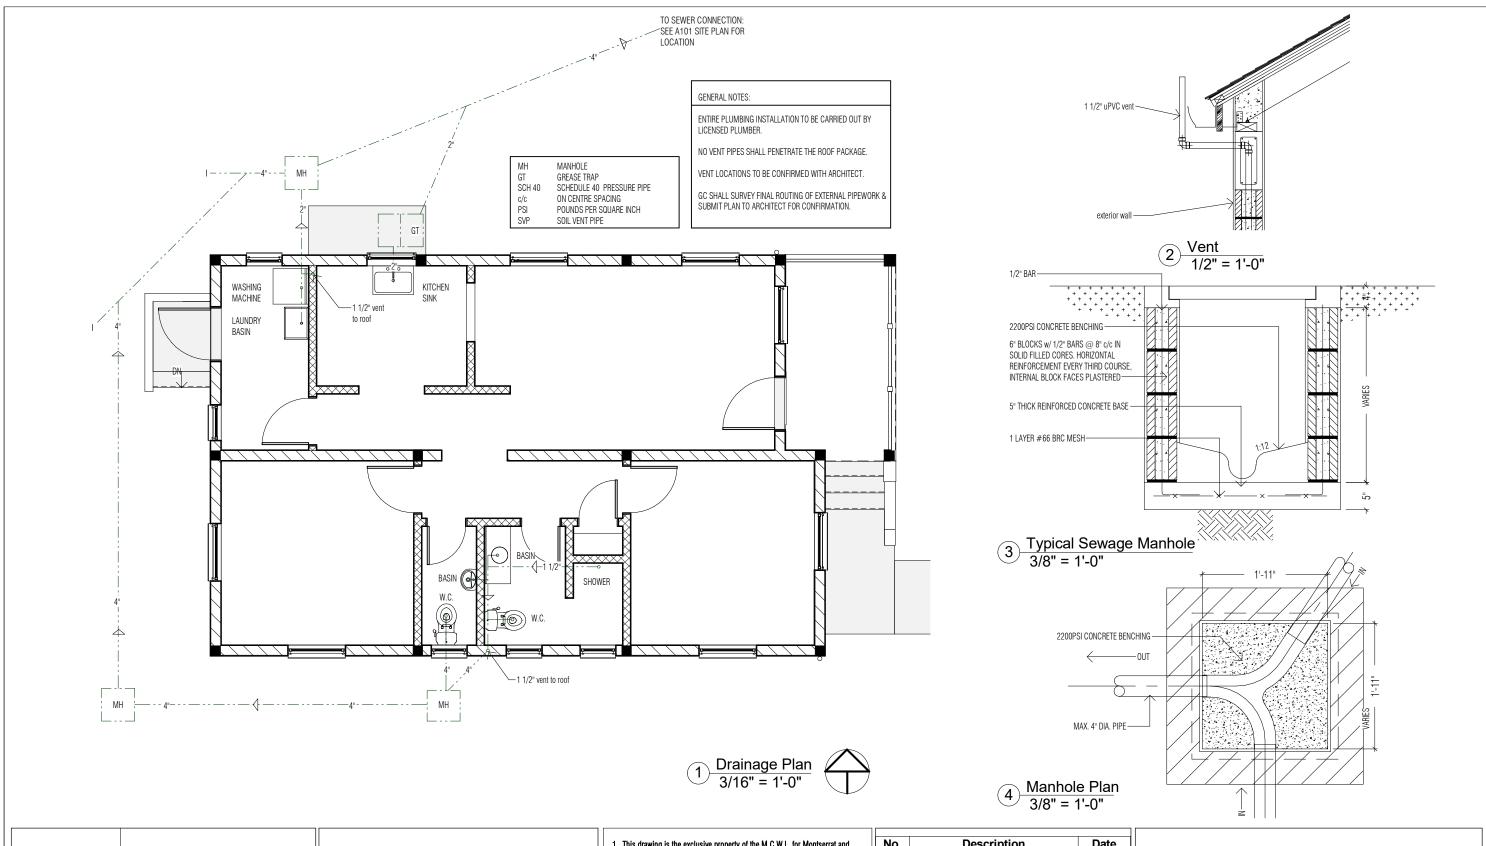



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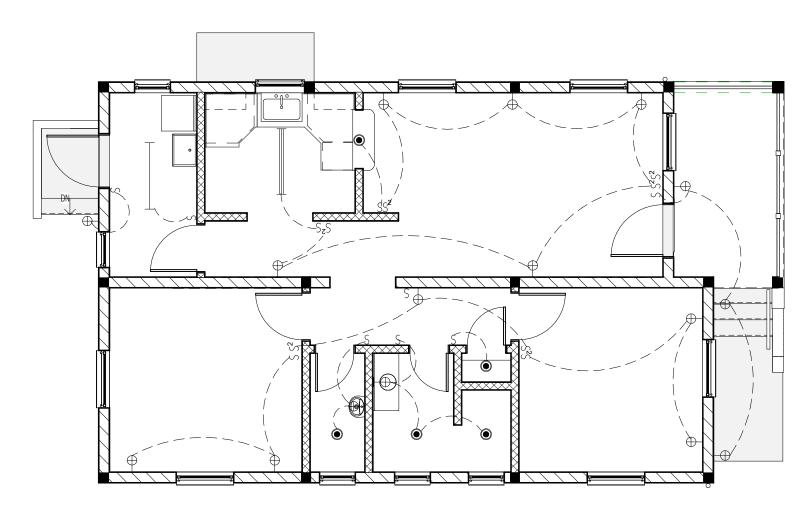
Social Housing - 2 Bedroom Unit @ Lot 157 Lookout, St. Johns, Montserrat

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Drainage Plan	
Diamayo i lan	

_	Diamage	ιιαπ		
\dashv	Project numbe	r CW-A-MP.33		
\dashv	Date	23-Nov-17	l A	\203
	Drawn by	Eug	_	
	Checked by	Eug	Scale	As indicated



	LEGEND
S	SINGLE POLE SWITCH
S²	3-WAY SWITCH
\oplus	WALL MOUNTED LIGHT FIXTURE
⊢⊕ _{WP}	WALL MOUNTED LIGHT FIXTURE (WEATHERED)
•	RECESSED LIGHT FIXTURE WATER VALVE
	4'-0" FLUORESCENT/LED LINEAR FIXTURE (SINGLE TUBE)
	4'-0" FLUORESCENT/LED LINEAR FIXTURE (DOUBLE TUBE)

1 Electrrical Plan_Lighting 3/16" = 1'-0"





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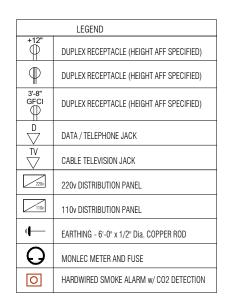
Social Housing - 2 Bedroom Unit @ Lot 157 Lookout, St. Johns, Montserrat


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Description	Date	
	Description	

ELECTRICAL LAYOUT - LIGHTING

Project numbe	r CW-A-MP.33			
Date	23-Nov-17	A204		
Drawn by	Eug	•	 .	
Checked by	Eug	Scale	3/16" = 1'-0"	



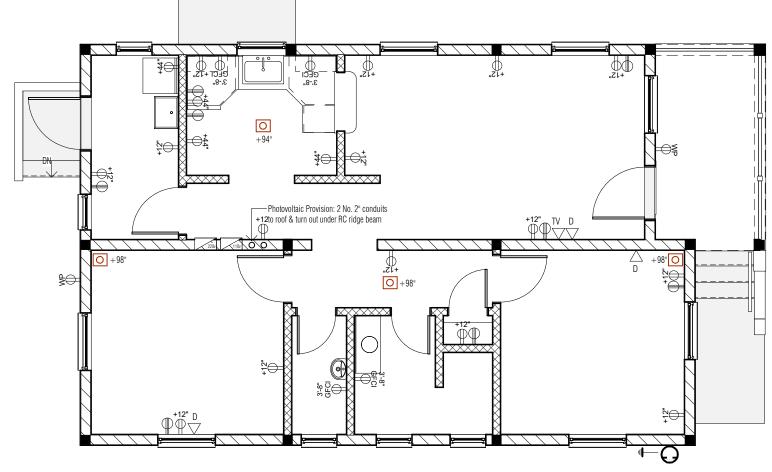

PAN	PANEL A CIRCUIT SCHEDULE (Social Housing - 2 Bed Unit)						
TYPE:	SPN (TYPE A) 8 WAYS SINGLE PHASE	DESCRIPTION: 240V POWER AND LIGHTING LOCATION: 2 Bed unit					
ISOLATOR: 100A DP VOLTAGE: 240 VOLTS AC		SUPPLY FROM: ELECTRICITY METER SUPPLY CALE LENGTH & SIZE = 16mm 2					
NO. OF		NO. OF	MCB	CABLE	EST.	EST.	
CIRCUIT	DESCRIPTION	POINTS	RTG. (A)	SIZE mm 2	LENGTH (M)	LOAD (A)	
1	LIGHTS: 2 Bed unit	8	5	1.5		10 Amps	
2	LIGHTS: 2 Bed unit	8	5	1.5		10 Amps	
3	LIGHTS: 2 Bed unit	7	5	1.5		10 Amps	
4	OUTLETS: 220 V Outlets	4	20	2.5		16 Amps	
5	OUTLETS: 220 V Outlets	3	20	2.5		16 Amps	
1							

PANEL B CIRCUIT SCHEDULE (Social Housing - 2 Bed Unit))

ISOLATO	SPN (TYPE A) 8 WAYS SINGLE PHASE R: 100A DP E: 110 VOLTS AC	LOCAT		nit el A via 5k	va transformer CALE LENGTH & S	SIZE
NO. OF		NO. OF	MCB	CABLE	EST.	EST.
CIRCUIT	DESCRIPTION	POINTS	RTG.	SIZE mm 2	LENGTH (M)	LOAD (A)

	NO. OF		NO. OF	MCB	CABLE	EST.	EST.	
CIRCUIT	DESCRIPTION	POINTS	RTG. (A)	SIZE mm 2	LENGTH (M)	LOAD (A)		
	1	OUTLETS: 2 Bed unit	7	20	2.5		20 Amps	
	2	OUTLETS: 2 Bed unit	7	20	2.5		20 Amps	
	3	OUTLETS: 2 Bed unit	7	20	2.5		20 Amps	
				•				





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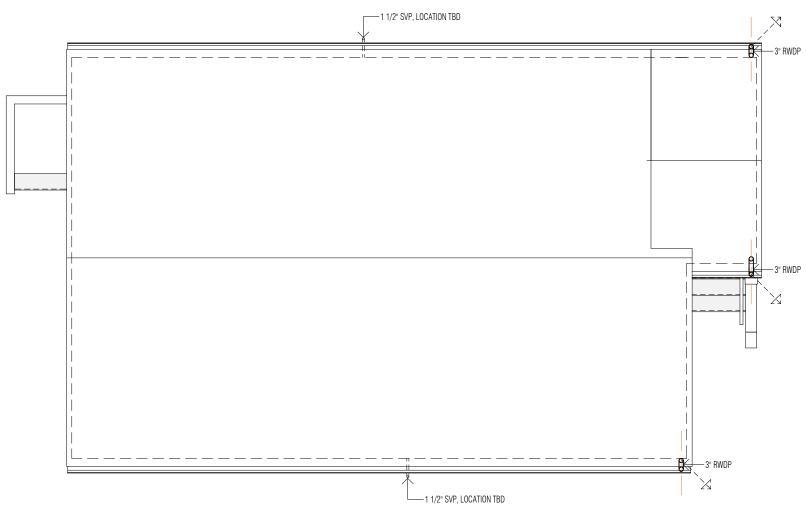
Social Housing - 2 Bedroom Unit @ Lot 157 Lookout, St. Johns, Montserrat


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01	Da	ite

ELECTRICAL LAYOUT - POWER

Project number	CW-A-MP.33		
Date	23-Nov-17		1205
Drawn by	Eug	•	1200
Checked by	Eug	Scale	3/16" = 1'-0"





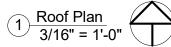

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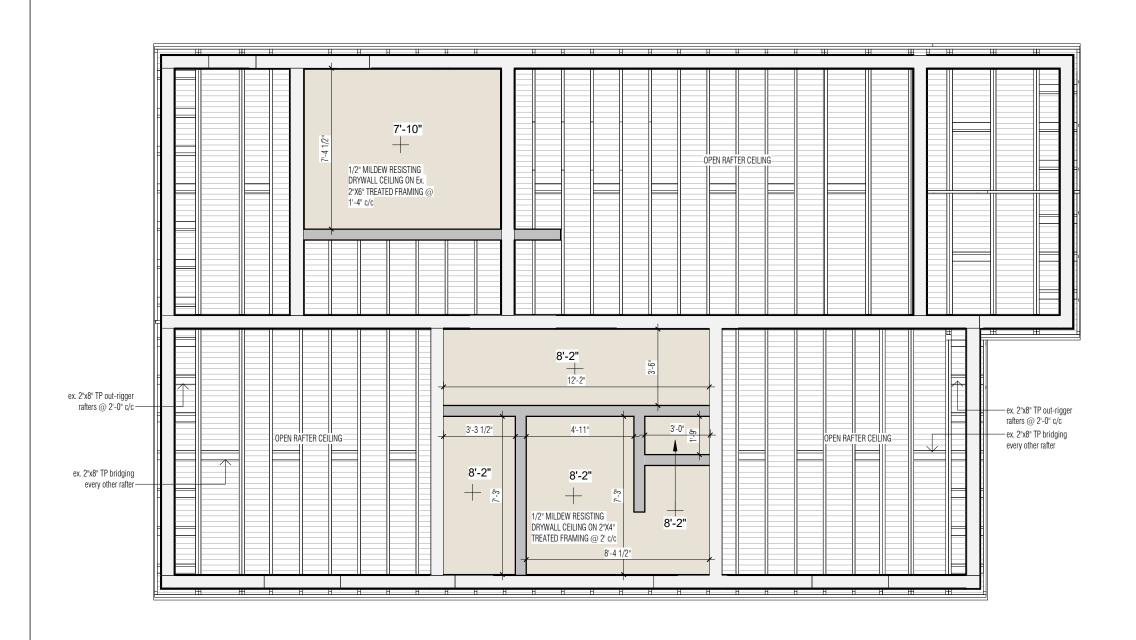
Social Housing - 2 Bedroom Unit @ Lot 157 Lookout, St. Johns, Montserrat


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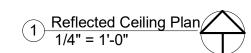
No.	Description	Date
01		

ROOF PLAN

11001 1				
Project numbe	r CW-A-MP.33	_		
Date	23-Nov-17	A206		
Drawn by	Author	•		
Checked by	Checker	Scale	3/16" = 1'-0"	





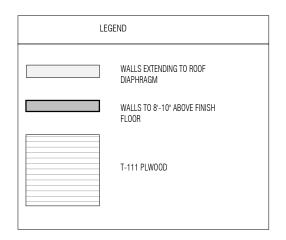



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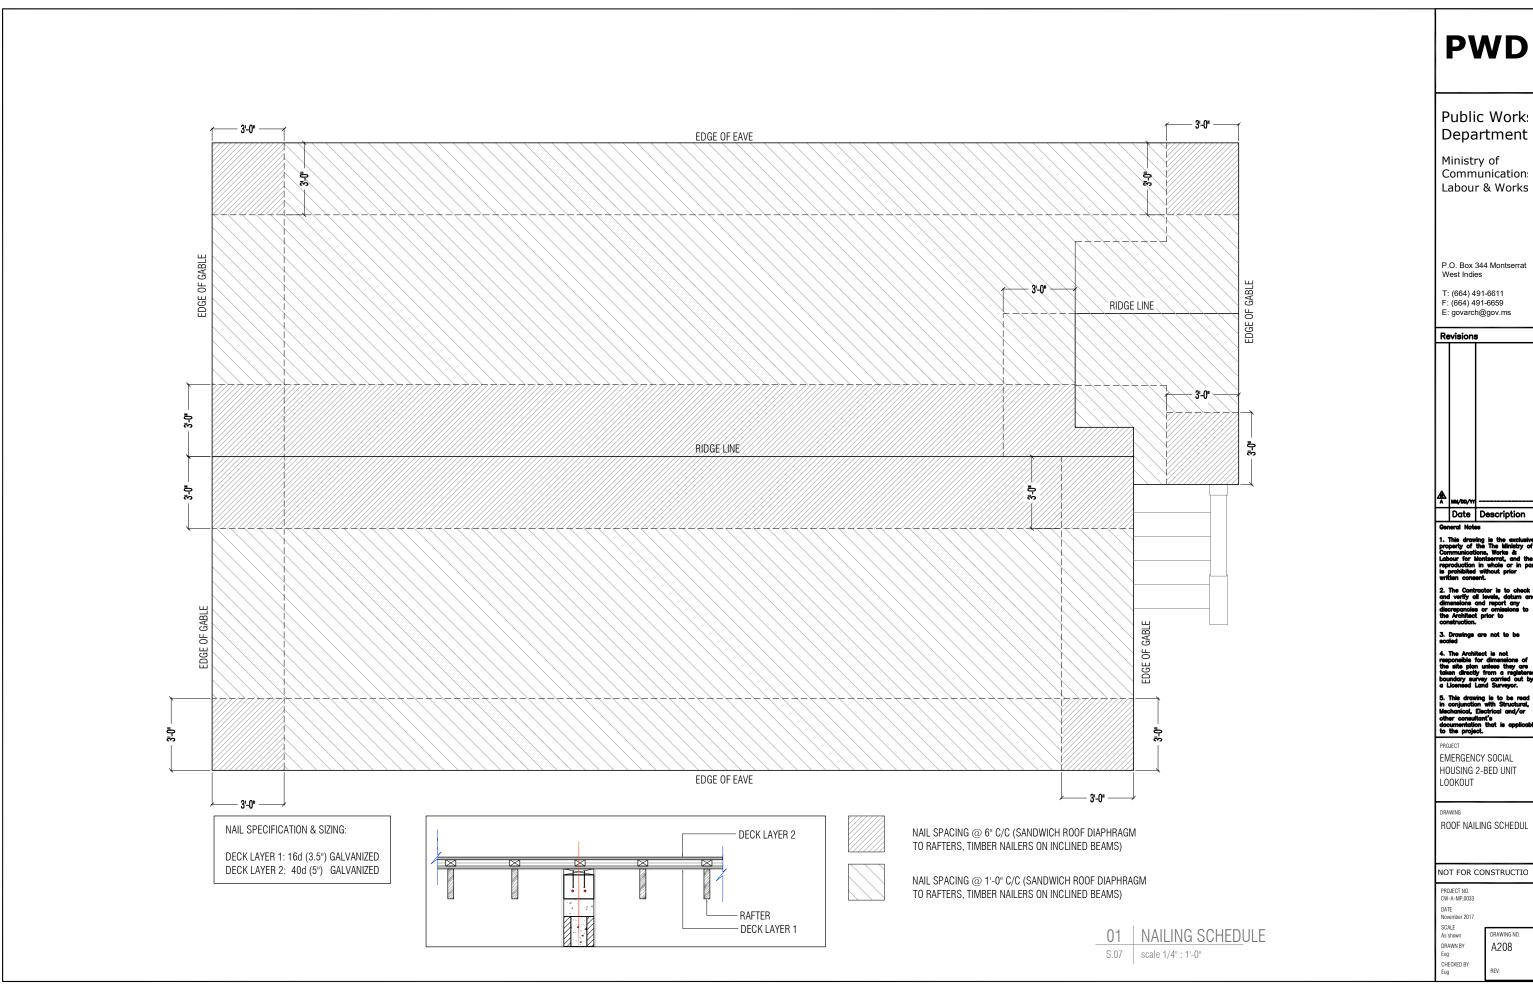
Social Housing - 2 Bedroom Unit @ Lot 157 Lookout, St. Johns, Montserrat

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Description	Date
	Description


Reflected	Ceiling	Plan

1101100100	o Coming i lan		
Project numbe	r CW-A-MP.33		–
Date	23-Nov-17		\ 207
Drawn by	Eug		
Checked by	Eug	Scale	1/4" = 1'-0"



Communication



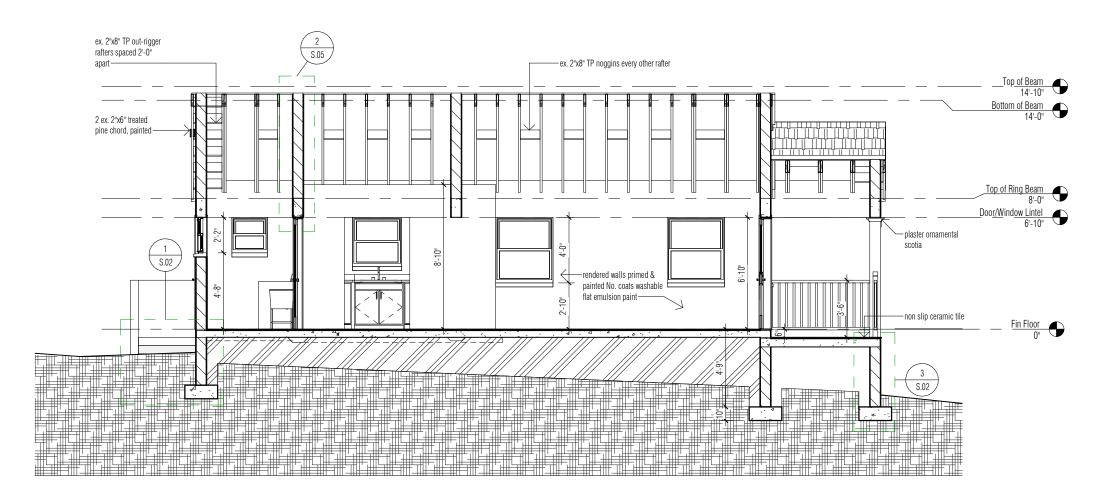

Section 1-1 3/16" = 1'-0"



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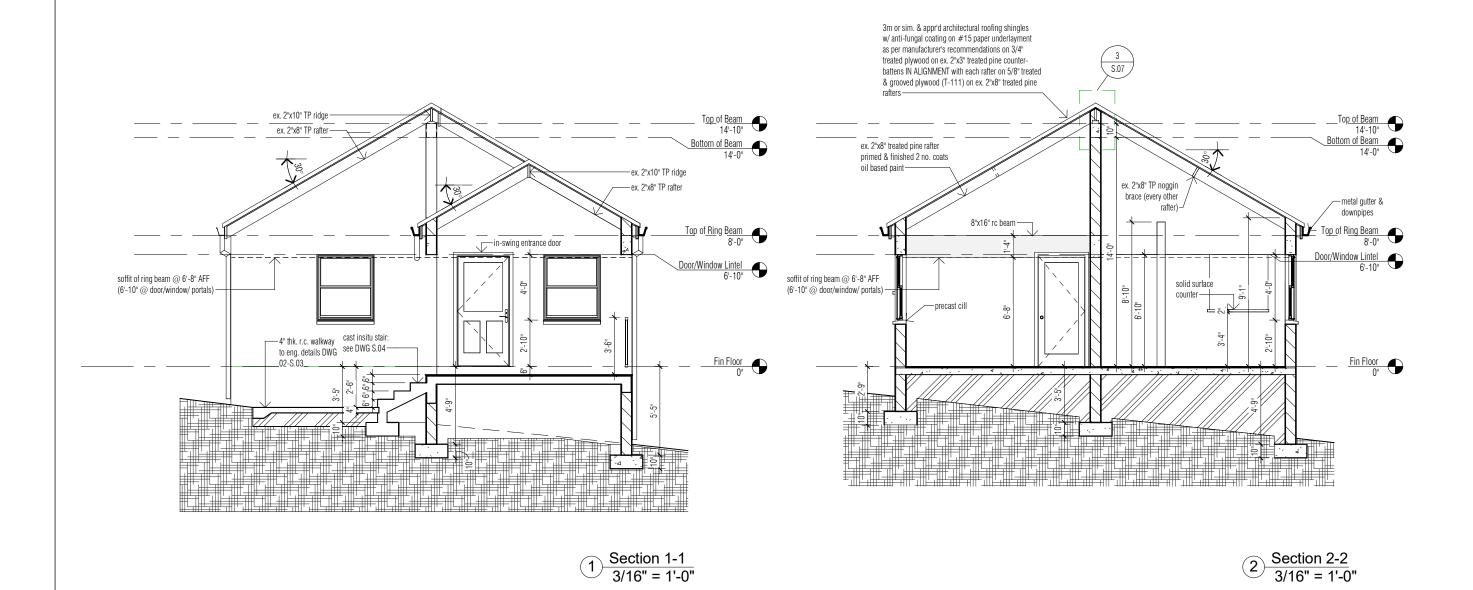
Social Housing - 2 Bedroom Unit @ Lot 157 Lookout, St. Johns, Montserrat

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Description	Date
	Description

SECTION 1-1

02011011				
Project number	CW-A-MP.33			
Date	23-Nov-17	A301		
Drawn by	Eug	_		
Checked by	Eug	Scale	3/16" = 1'-0"	



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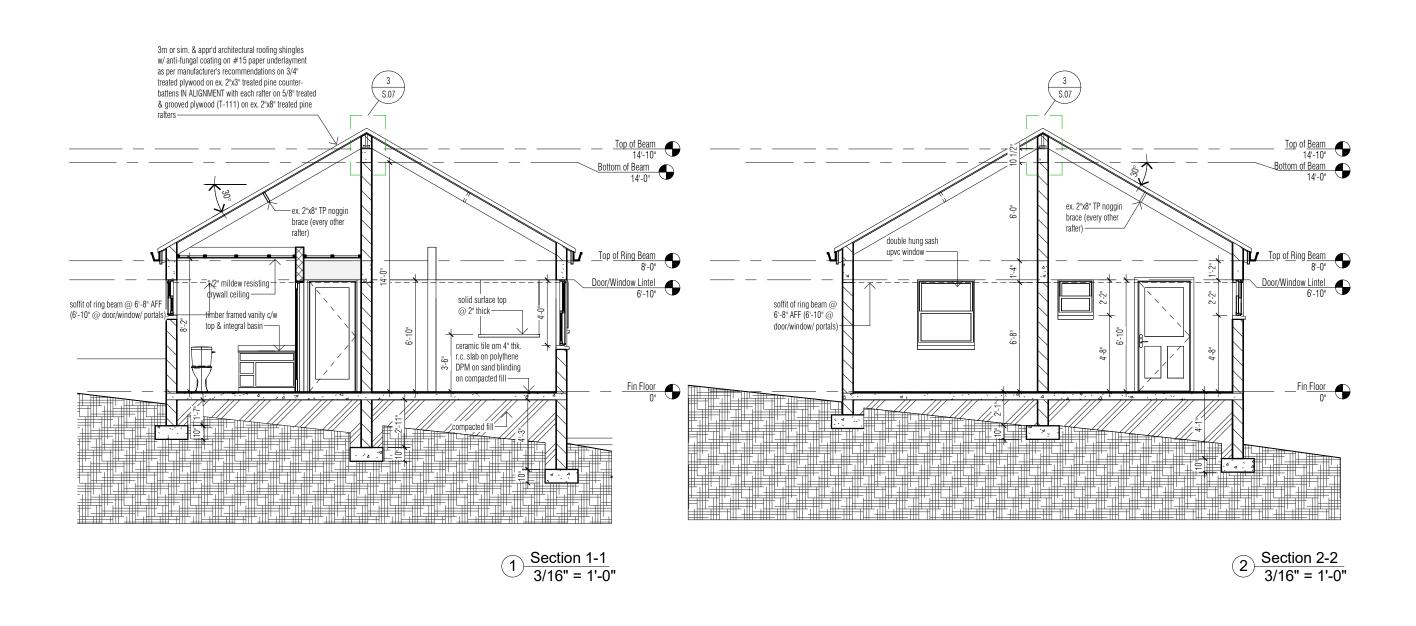
Social Housing - 2 Bedroom Unit @ Lot 157 Lookout, St. Johns, Montserrat

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No.	Description	Date
01		

SECTIONS 1-1 & 2-2

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\dashv	Project numbe	r CW-A-MP.33		
\dashv	Date	23-Nov-17		4302
\dashv	Drawn by	Eug	•	
\exists	Checked by	Eug	Scale	3/16" = 1'-0"





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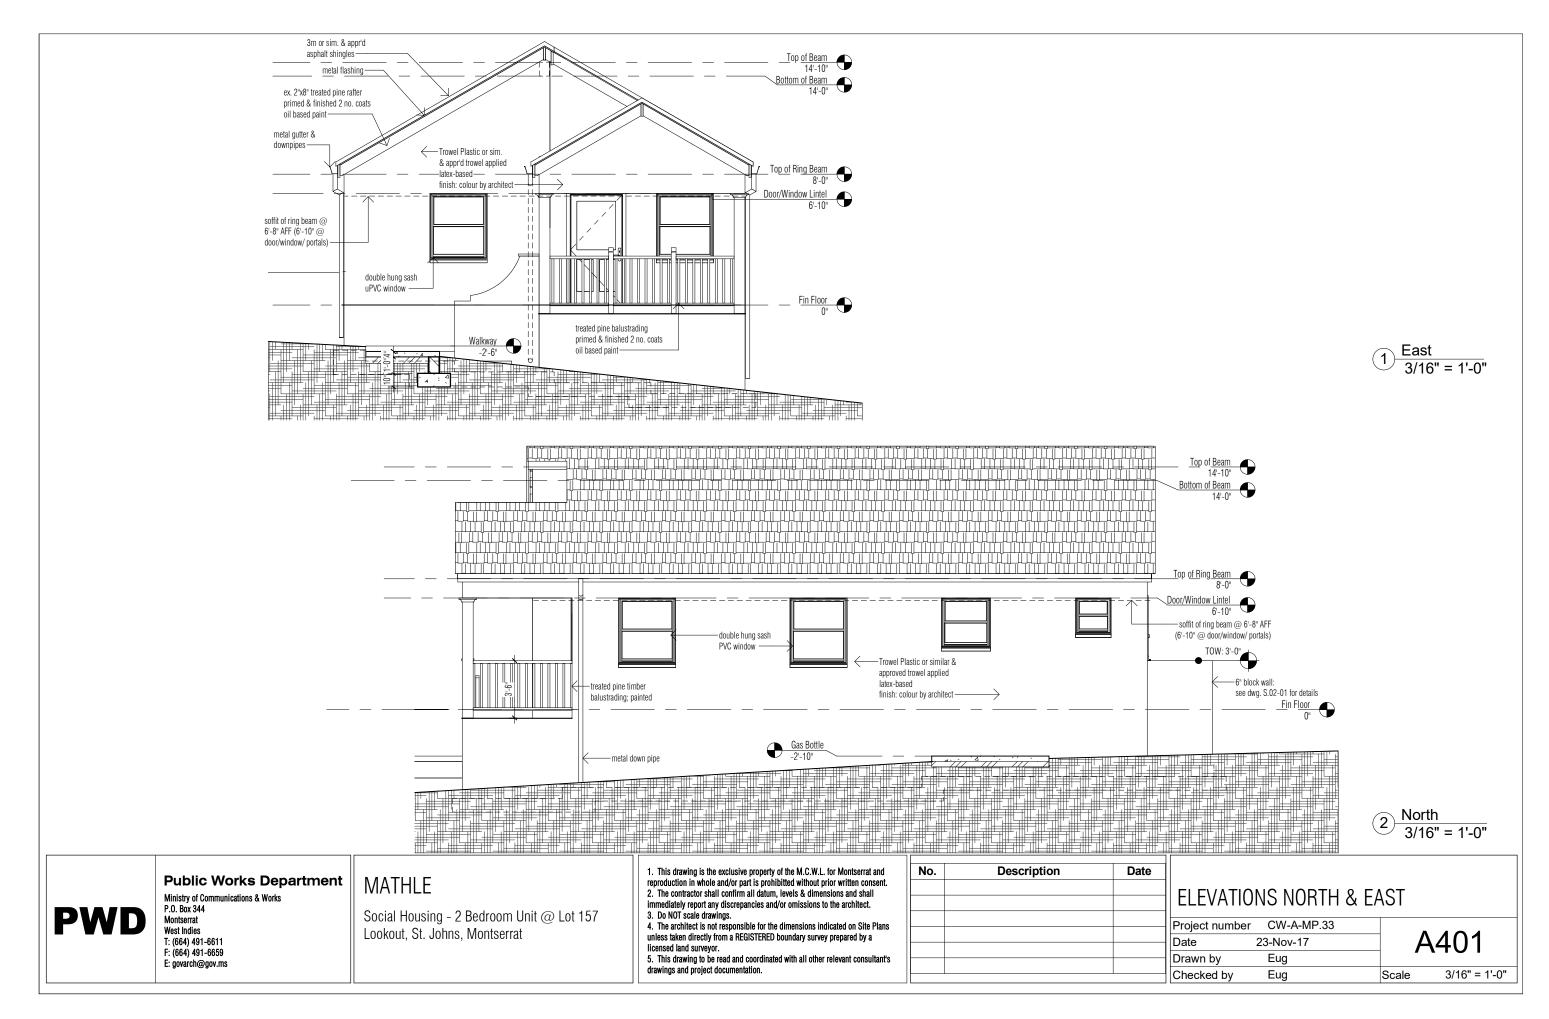
Social Housing - 2 Bedroom Unit @ Lot 157 Lookout, St. Johns, Montserrat


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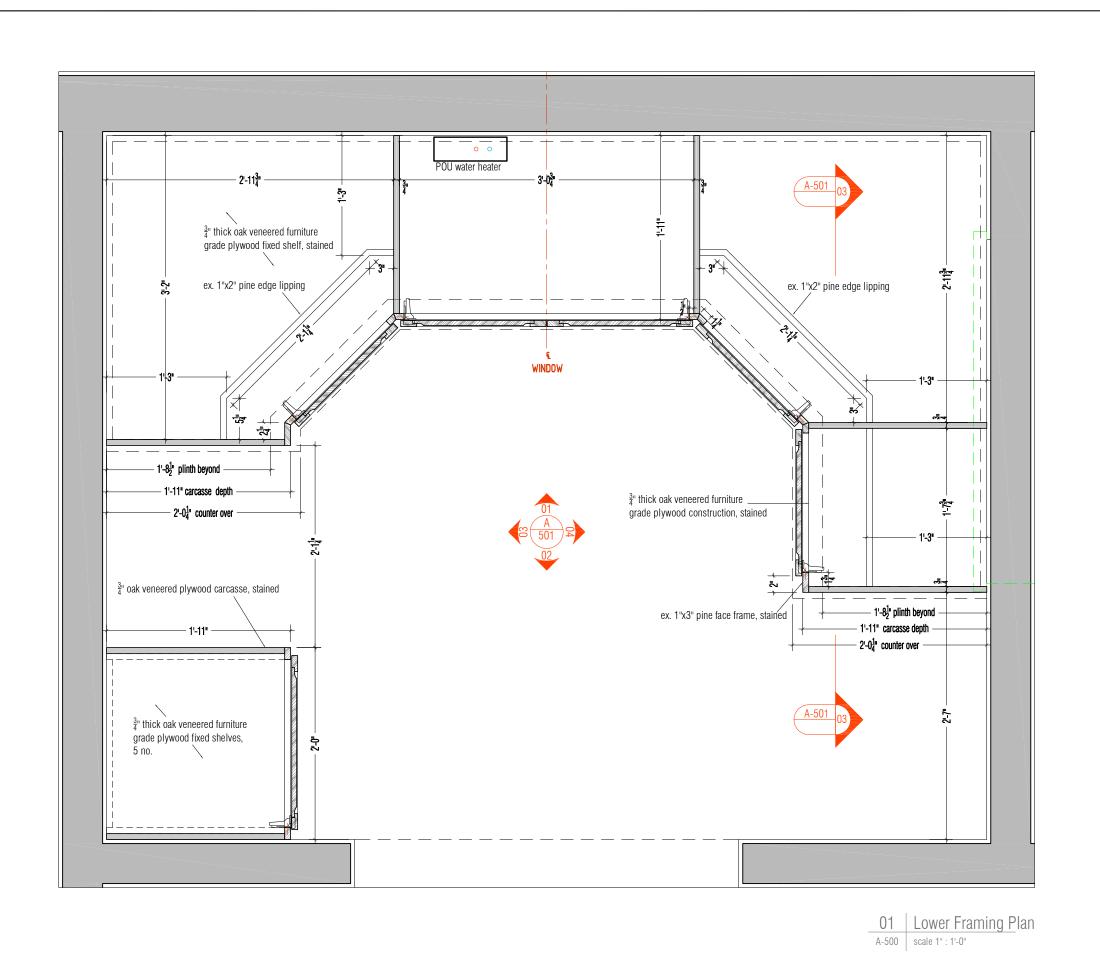
No.	Description	Date
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SECTIONS 1-1 & 2-2

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\dashv	Project numbe	r CW-A-MP.33		
\dashv	Date	23-Nov-17	/	A303
\dashv	Drawn by	Author	_	.000
\dashv	Checked by	Eug	Scale	3/16" = 1'-0"
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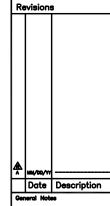


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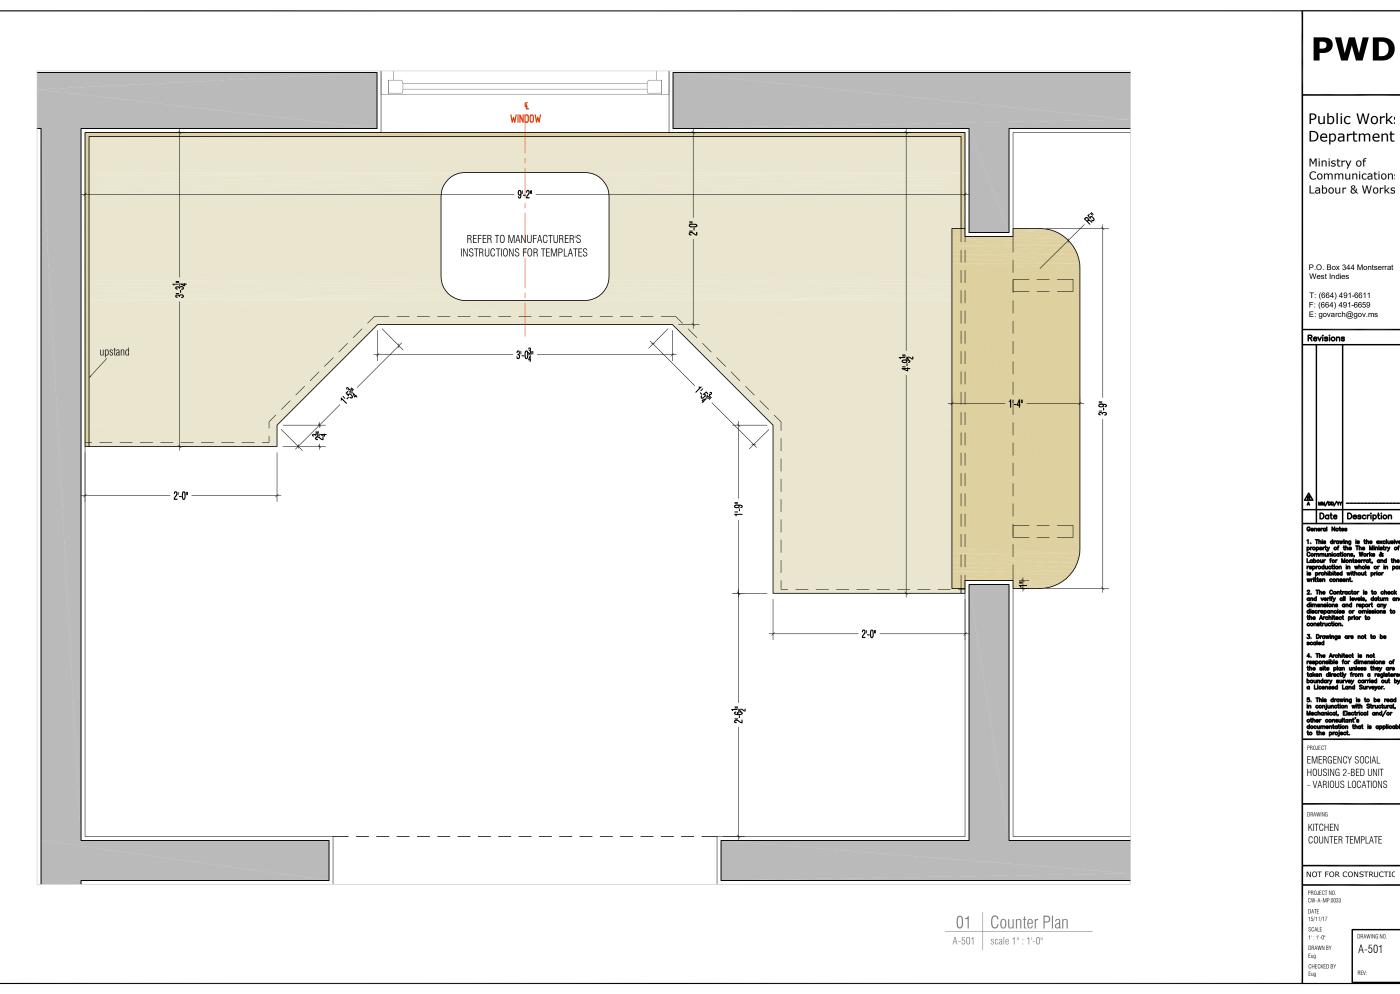
EMERGENCY SOCIAL HOUSING 2-BED UNIT - VARIOUS LOCATIONS

KITCHEN LOWER CABINET -FRAMING PLAN

NOT FOR CONSTRUCTIO

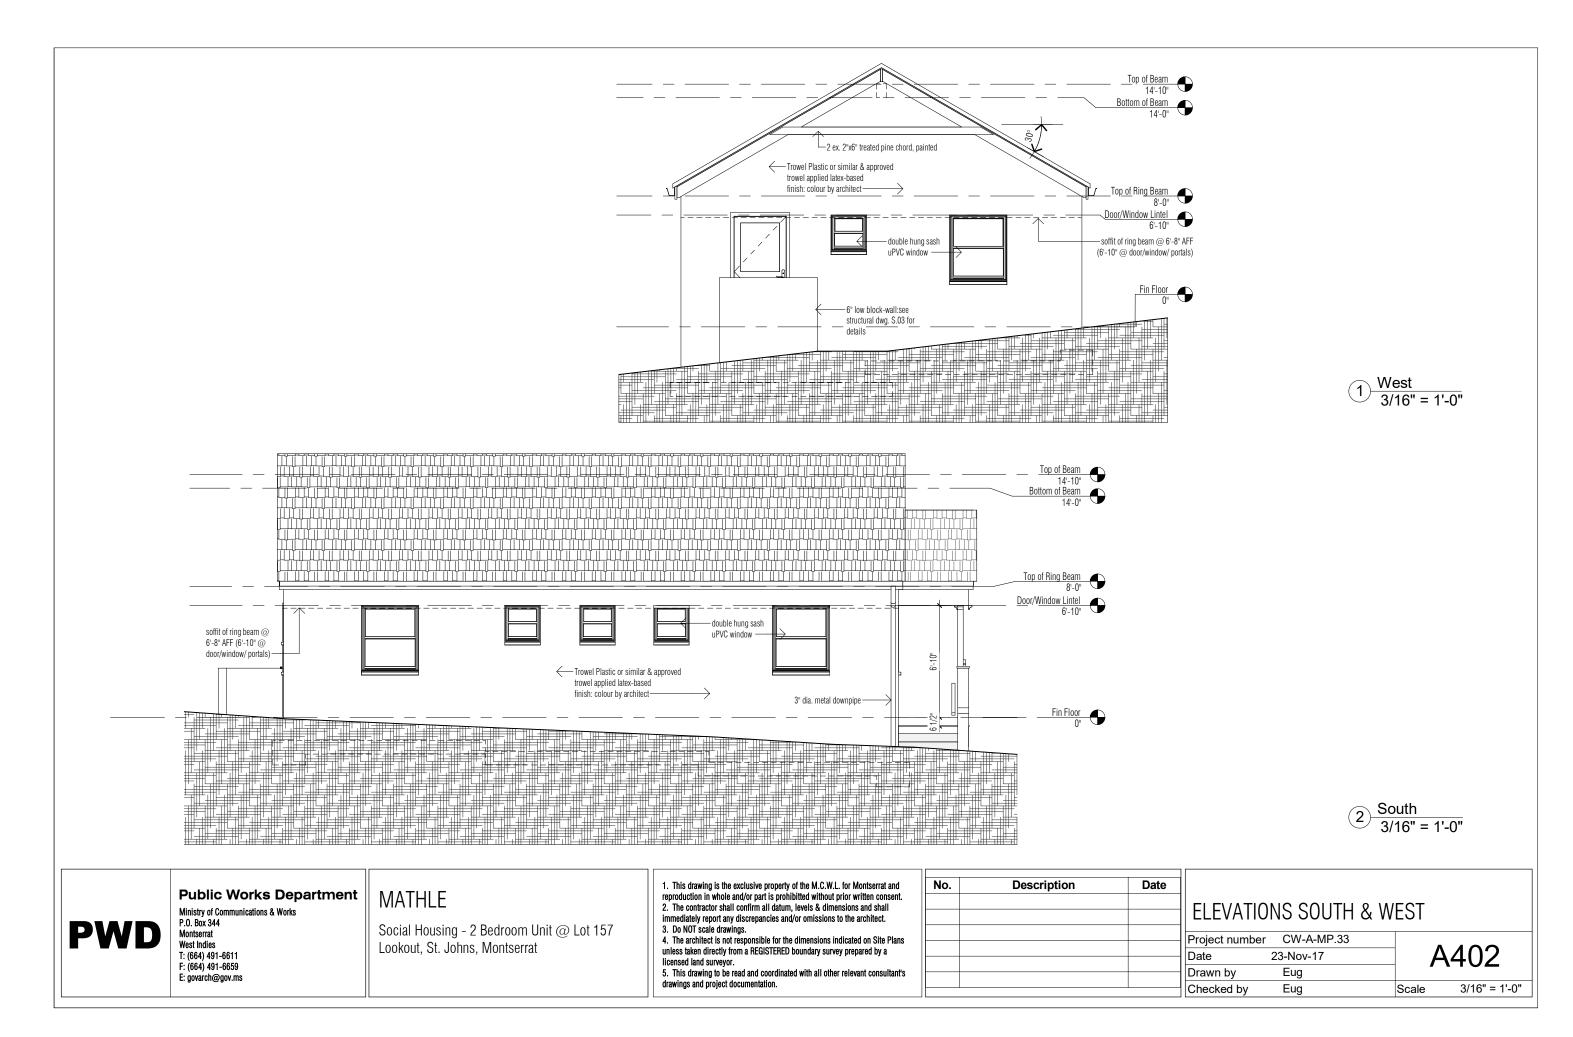
PROJECT NO. CW-A-MP.0033 SCALE 1': 1'-0"


DRAWING NO. DRAWN BY Eug CHECKED BY Eug A-500



Department

Labour & Works

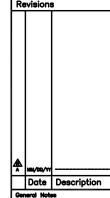

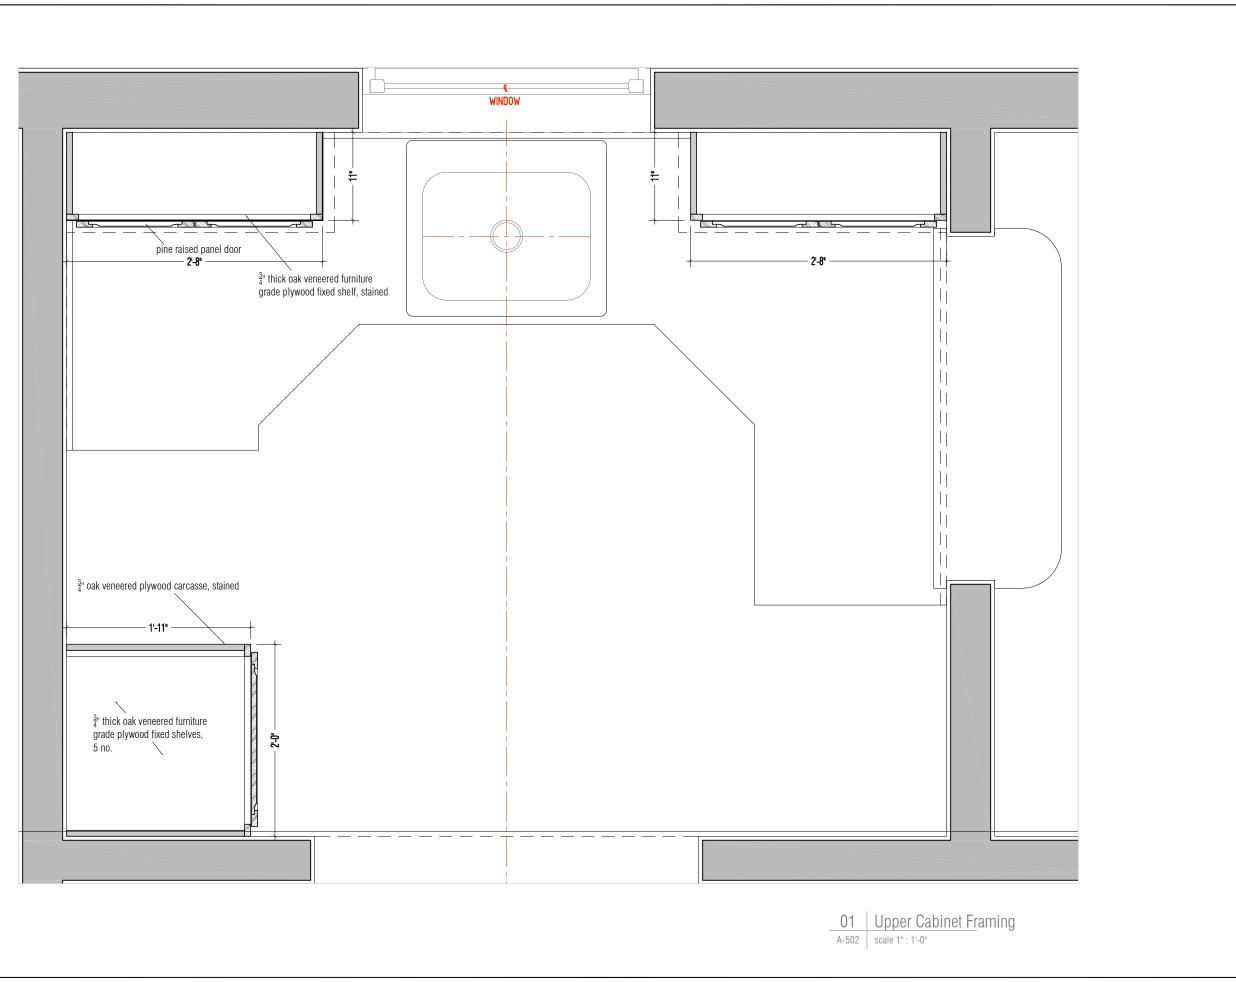


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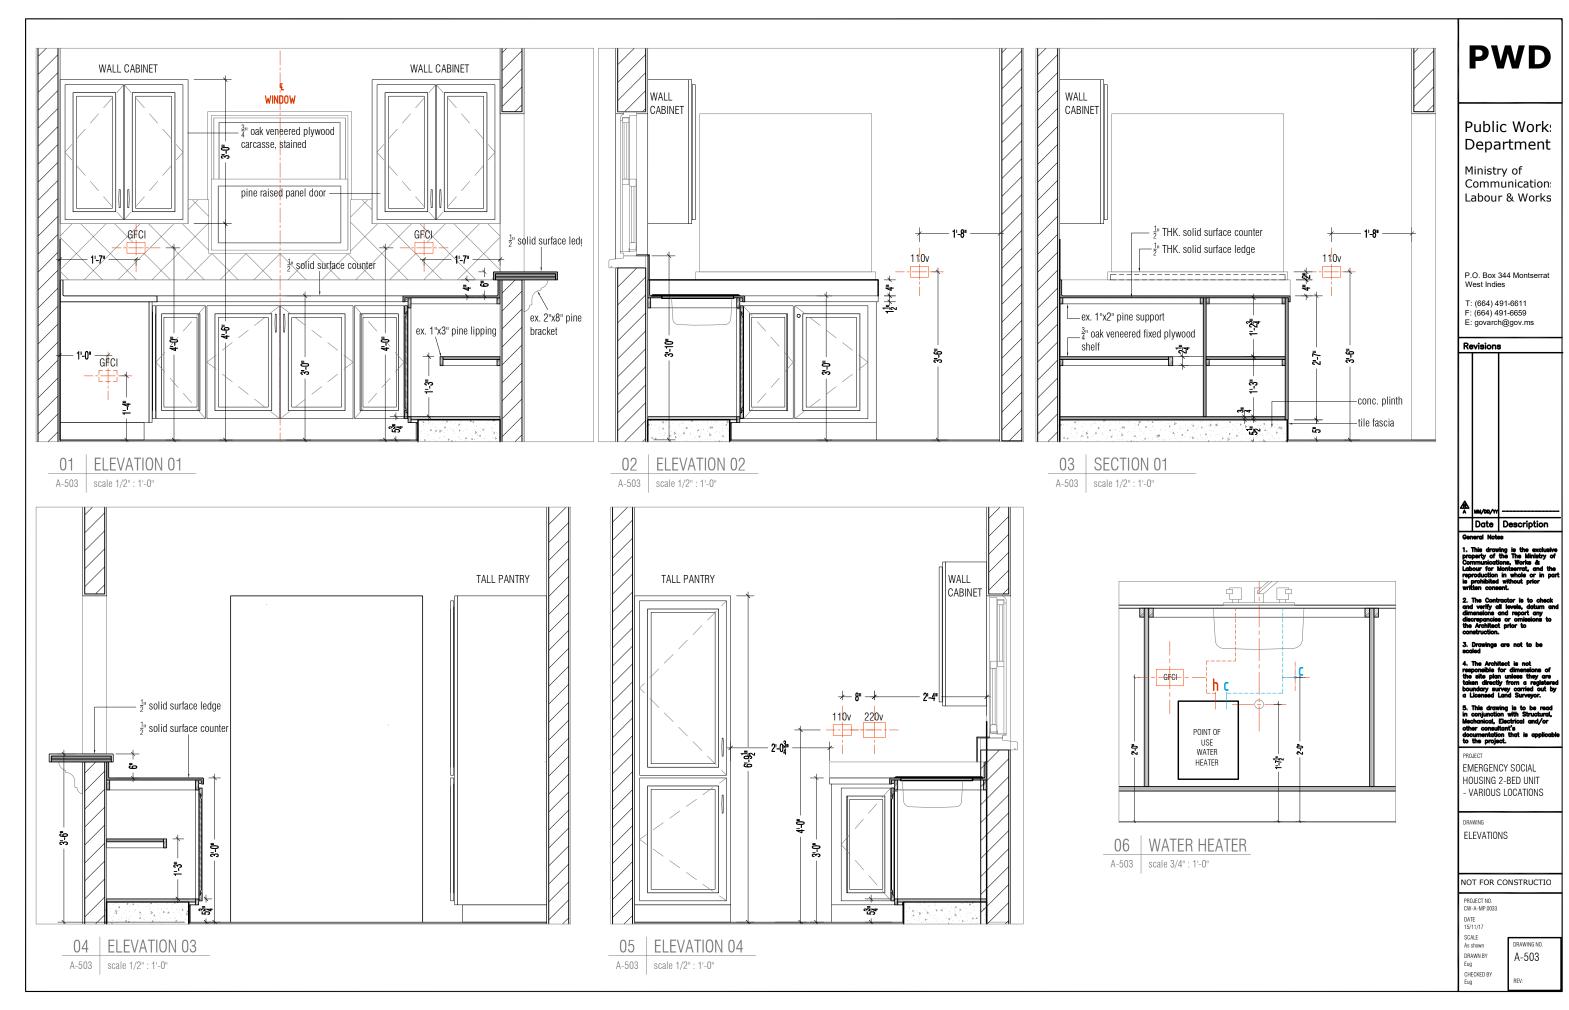
EMERGENCY SOCIAL HOUSING 2-BED UNIT - VARIOUS LOCATIONS


KITCHEN UPPER CABINETS

NOT FOR CONSTRUCTIO


PROJECT NO. CW-A-MP.0033 SCALE 1': 1'-0"

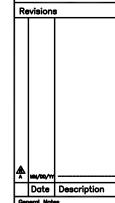DRAWING NO. DRAWN BY Eug CHECKED BY Eug A-502




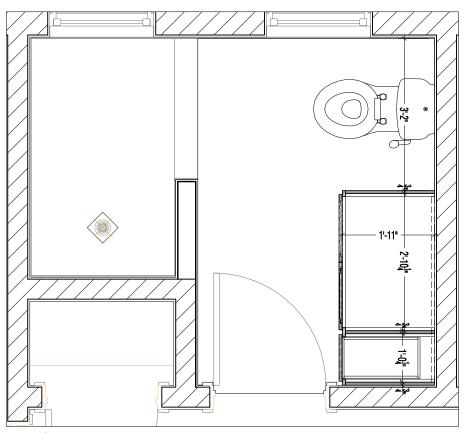


01 Lower Framing A-510 scale 1/2" : 1'-0"

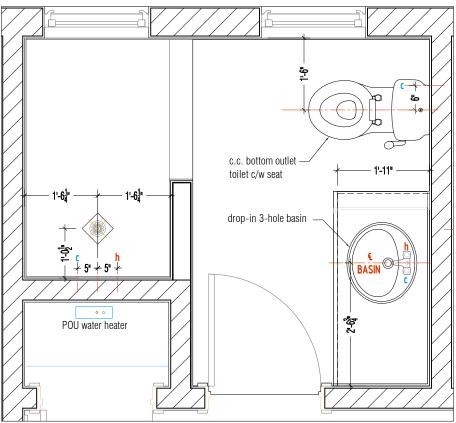

01 | Plumbing A-510 | scale 1/2" : 1'-0"

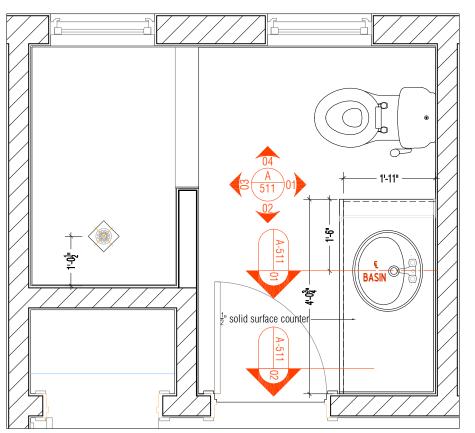

02 | Counter Level A-510 scale 1/2": 1'-0"

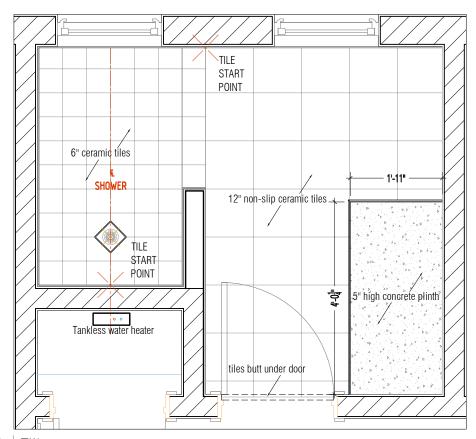

A-510 | scale 1/2" : 1'-0"

PWD

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Revisions

Date Description


EMERGENCY SOCIAL HOUSING 2-BED UNIT - VARIOUS LOCATIONS

BATHROOM PLANS

NOT FOR CONSTRUCTIO

PROJECT NO. CW-A-MP.0033

SCALE as shown DRAWN BY Eug CHECKED BY Eug DRAWING NO. A-510

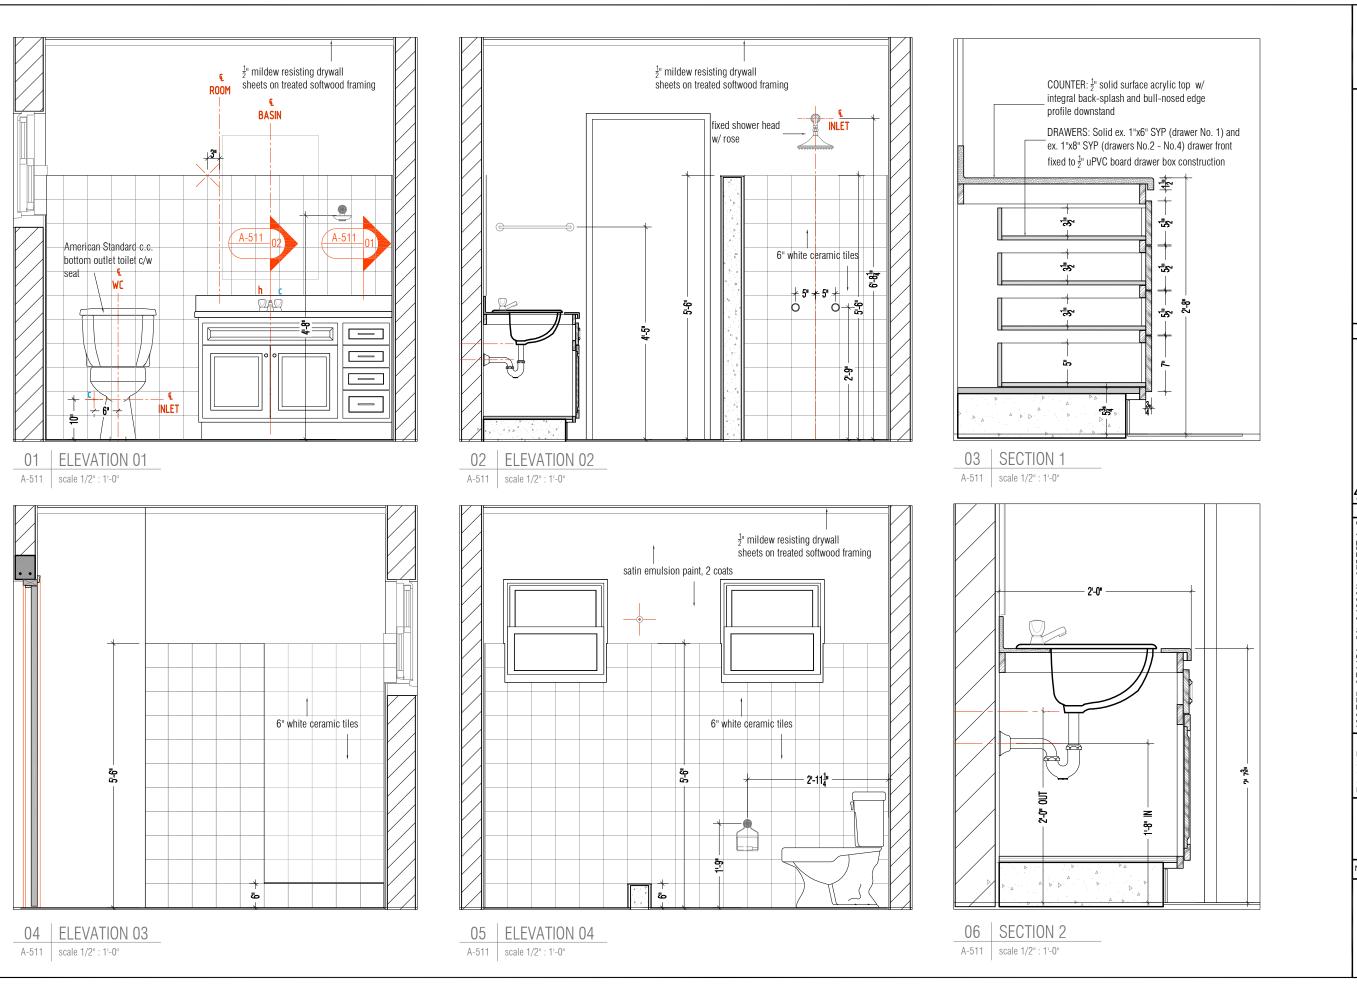

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Revisions Date Description


EMERGENCY SOCIAL HOUSING 2 BED UNIT @ Lot 192 - VARIOUS LOCATIONS, ST JOHNS MONTSERRAT

BATHROOM ELEVATIONS

NOT FOR CONSTRUCTIO


PROJECT NO. CW-A-MP.0033 SCALE as shown

DRAWING NO. DRAWN BY Eug A-511 CHECKED BY Eug

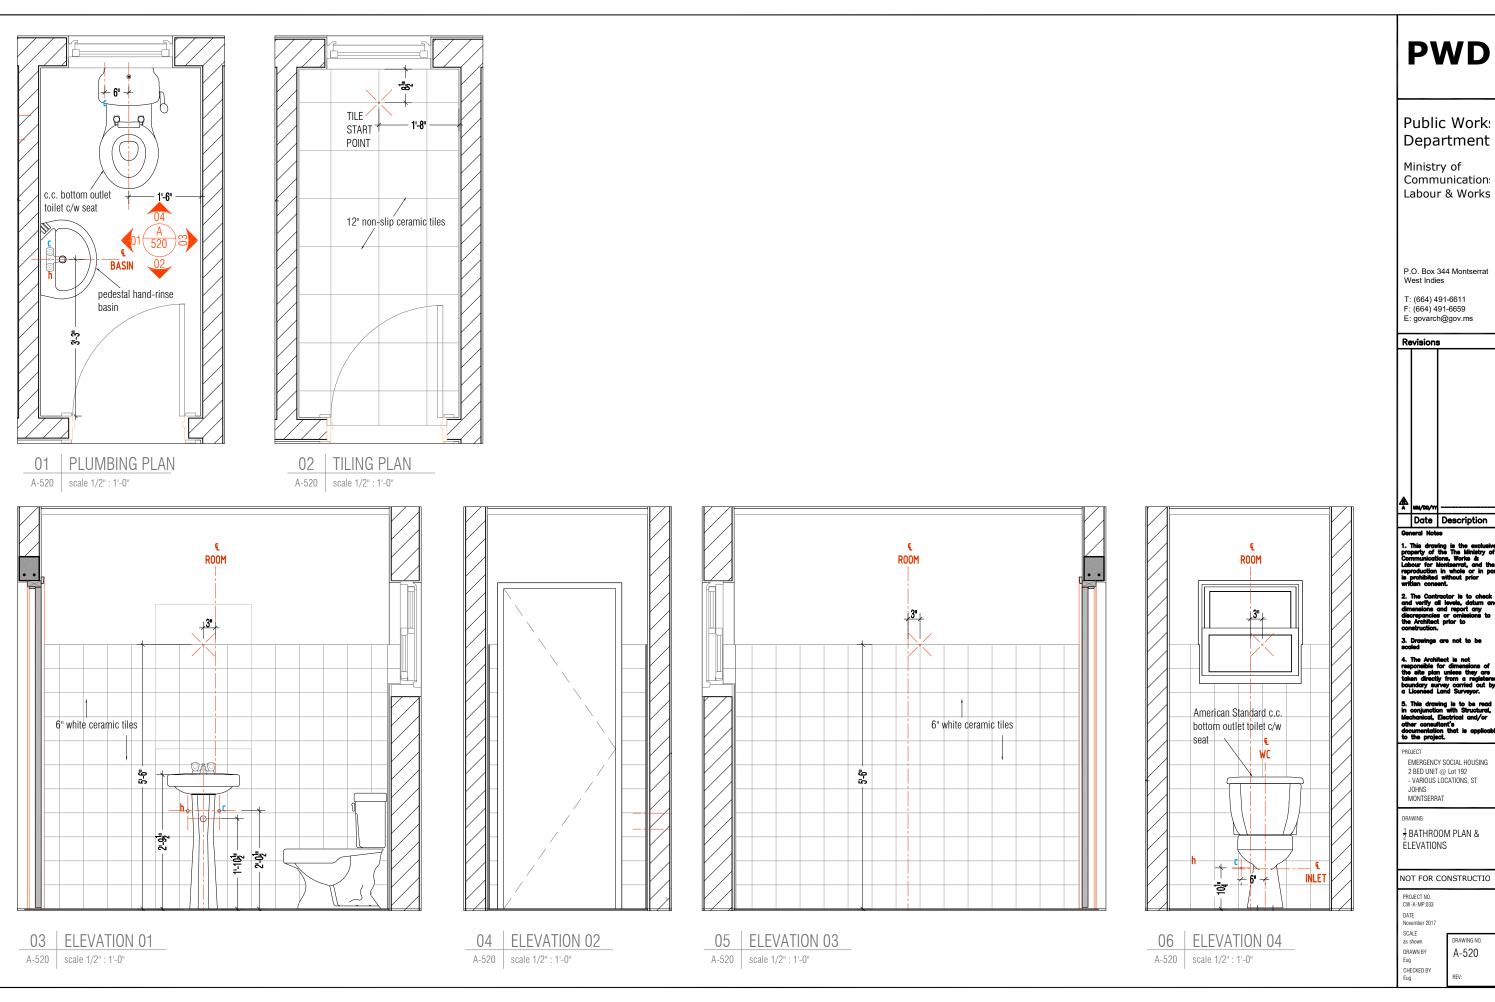


Department


Communication

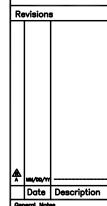



DRAWING NO. A-520

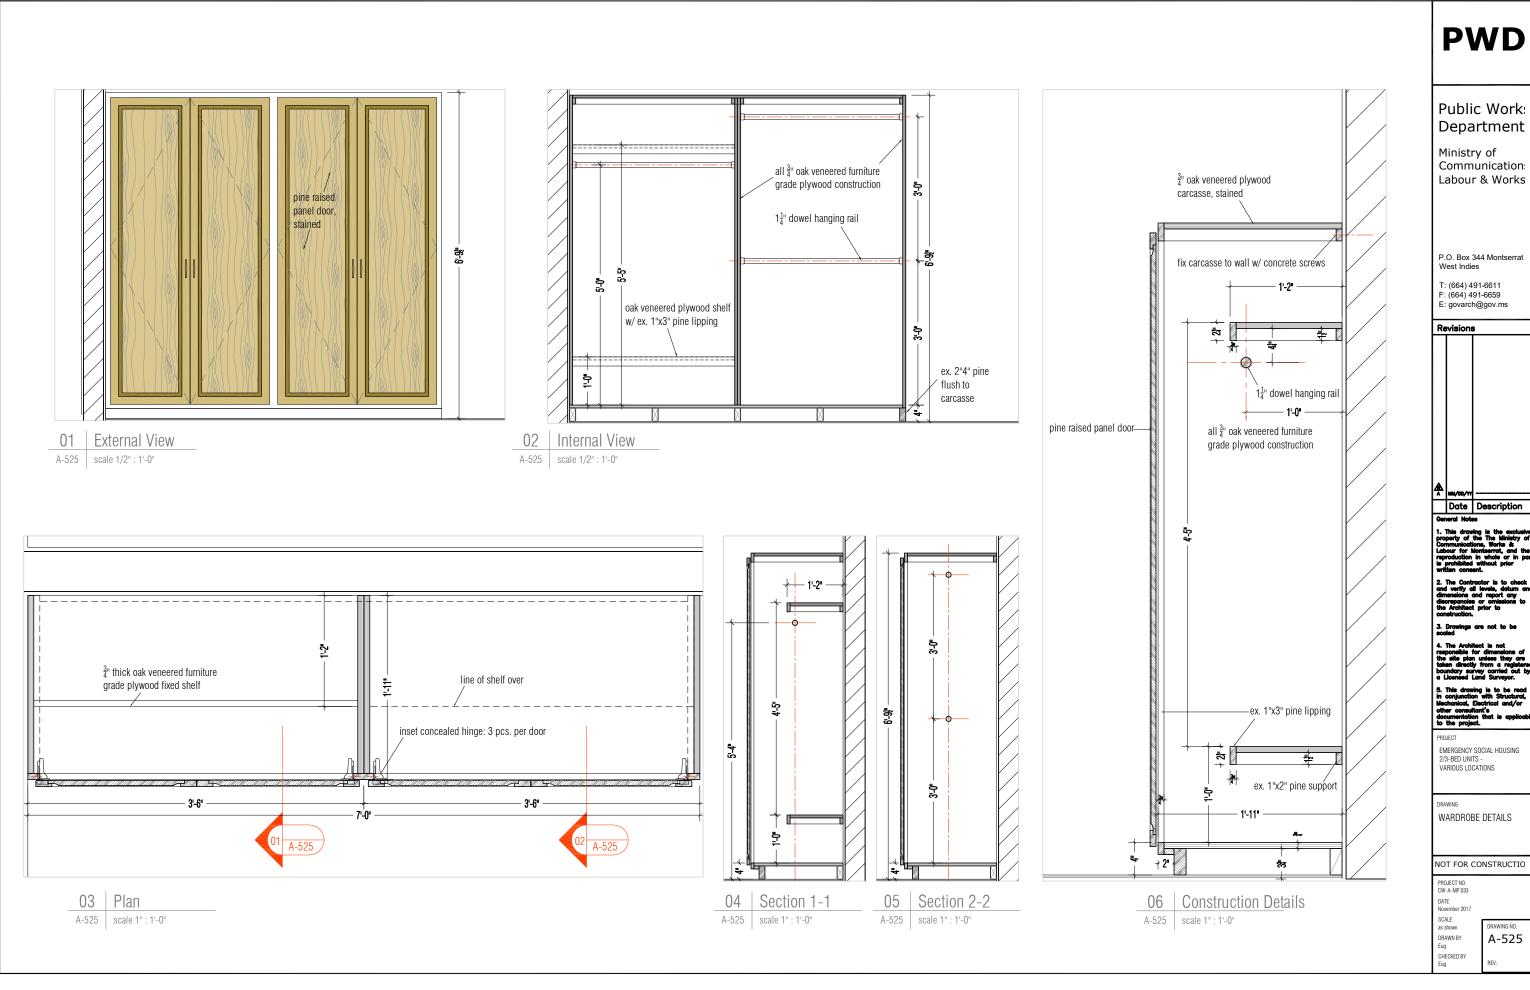



Communication

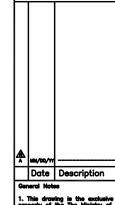

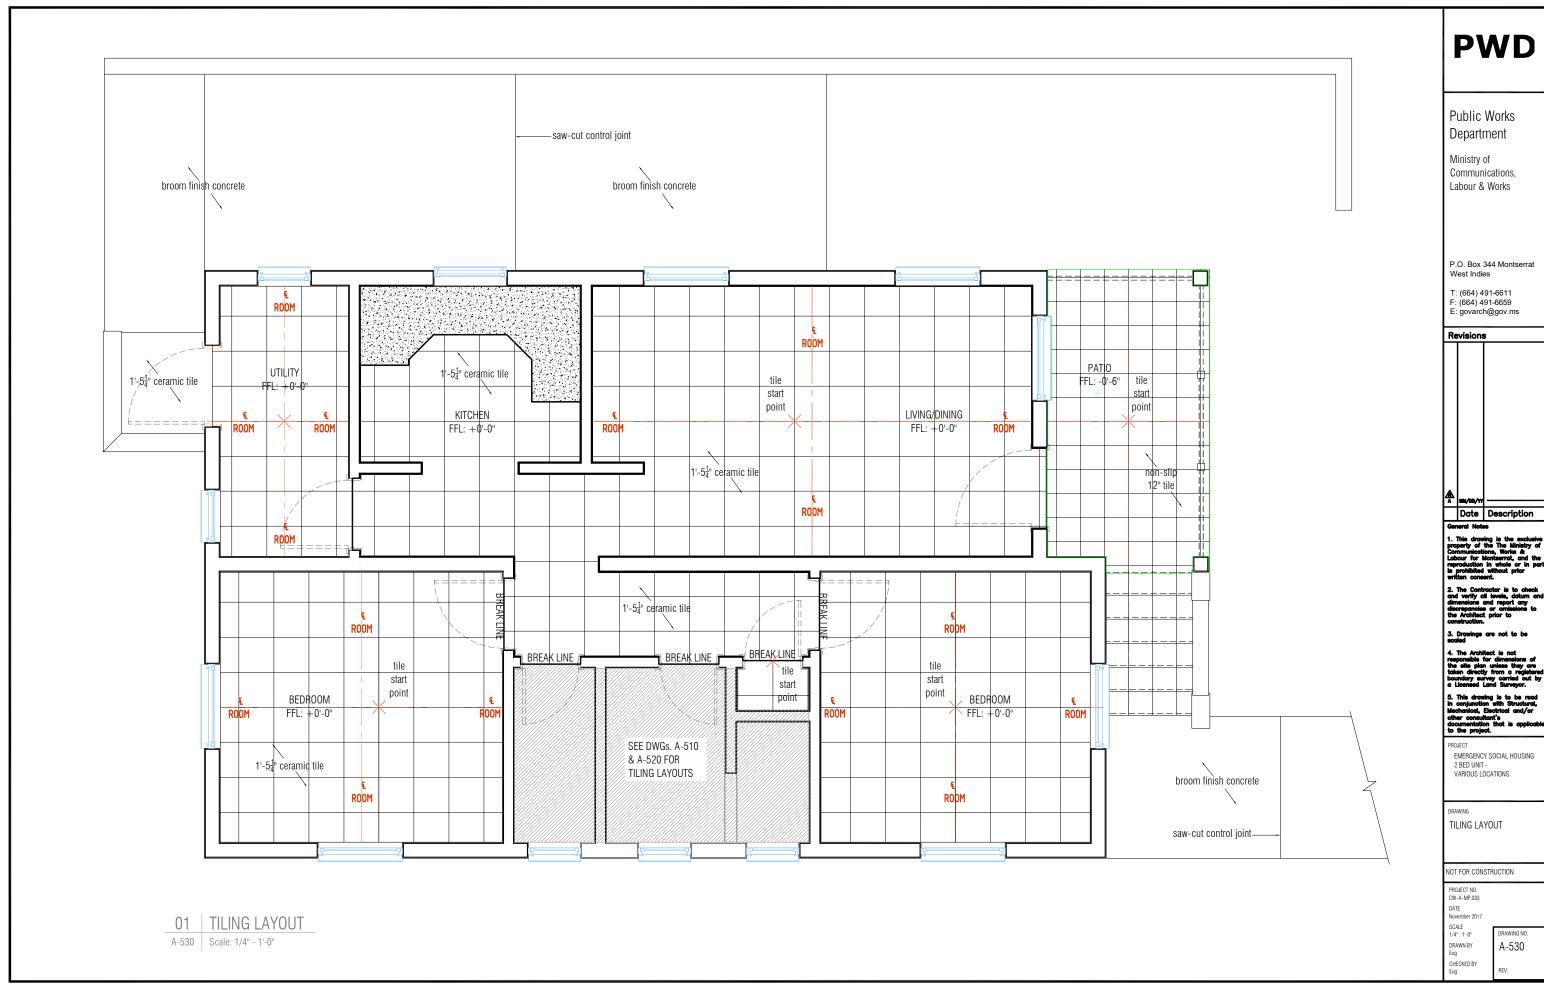

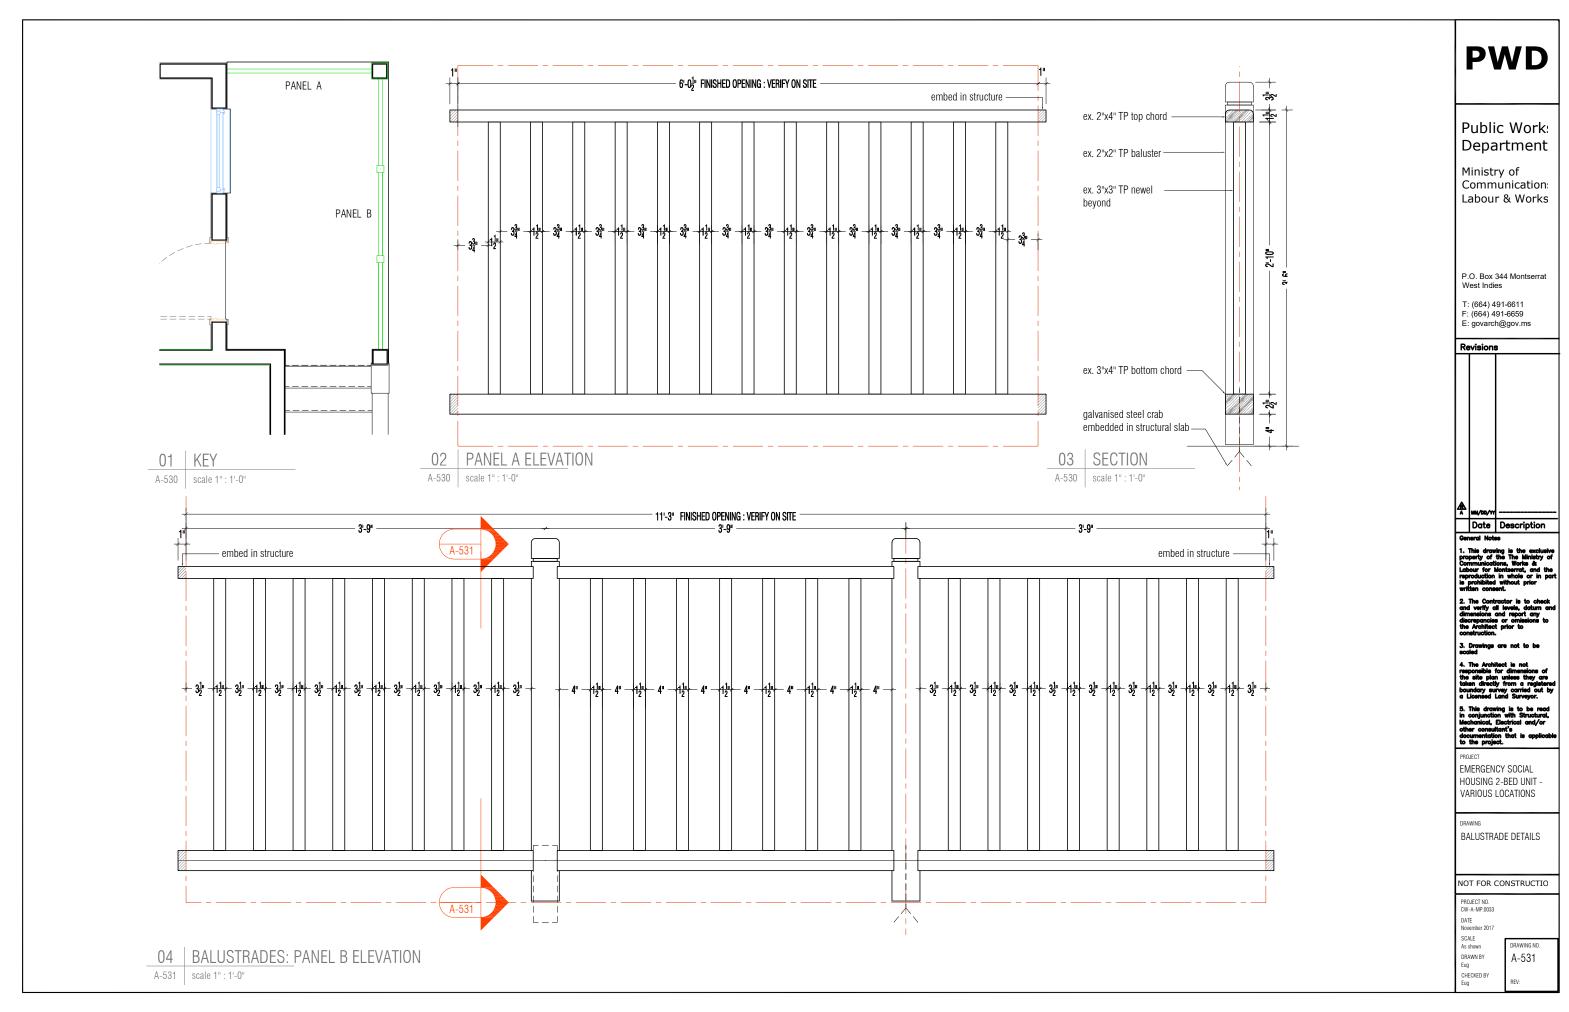

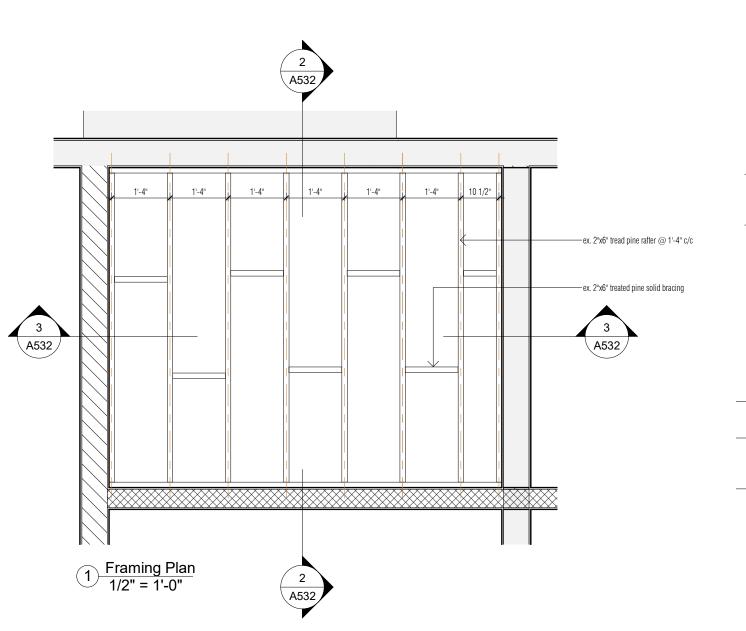

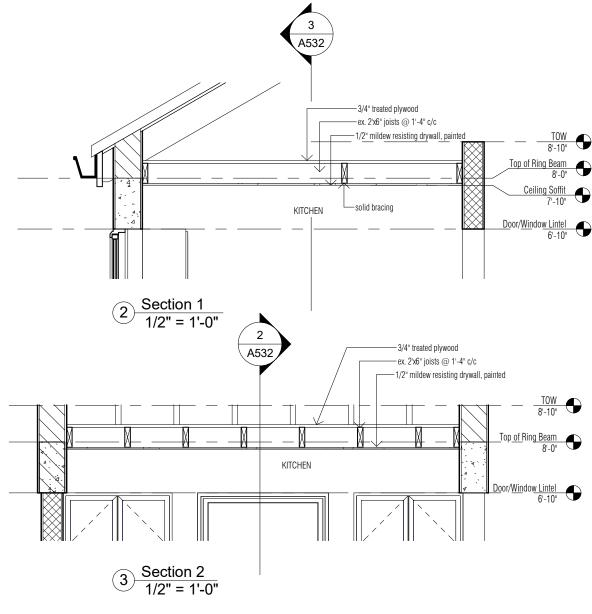



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Social Housing - 2 Bedroom Unit @ Lot 157 Lookout, St. Johns, Montserrat

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No.	Description	Date		

STORAGE LOFT DETAILS

Project number	r CW-A-MP.33		_			
Date	23-Nov-17	Nov-17 A532				
Drawn by	Eug		•	.002		
Checked by	Eug		Scale	1/2" = 1'-0"		

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	Re	visions	3
	¥	MM/00/YY	
			Description
	Gen	neral Note	18

EMERGENCY SOCIAL HOUSING 2-BED UNITS -VARIOUS LOCATIONS

WINDOW SCHEDULE

NOT FOR CONSTRUCTIO

PROJECT NO. CW-A-MP.033

DATE November 2017 SCALE NA DRAWN BY Eug CHECKED BY Eug

A-600

MATHLE SOCIAL HOUSING: 2 BEDROOM UNIT WINDOW SCHEDULE

WINDO WNo.	LOCATION	STYLE	SI	ZE	MATERIAL	INSECT SCREEN	IMPACT	SHUTTER	CILL HEIGHT	HEAD HEIGHT	COMMENTS
			WIDTH	HEIGHT							
1	BEDROOM 01	UPVC DOUBLE HUNG	3'-6"	4'-0"	uPVC	YES	NO	DEMOUNTABLE CORRUGATED POLY	2'-10"	6'-10"	
2	BEDROOM 01	UPVC DOUBLE HUNG	3'-6"	4'-0"	uPVC	YES	NO	DEMOUNTABLE CORRUGATED POLY	2'-10"	6'-10"	
3	BATHROOM	UPVC DOUBLE HUNG	2'-2"	2'-2"	uPVC	YES	NO	DEMOUNTABLE CORRUGATED POLY	4'-8"	6'-10"	
4	BATHROOM	UPVC DOUBLE HUNG	2'-2"	2'-2"	uPVC	YES	NO	DEMOUNTABLE CORRUGATED POLY	4'-8"	6'-10"	
5	1/2 BATH	UPVC DOUBLE HUNG	2'-2"	2'-2"	uPVC	YES	NO	DEMOUNTABLE CORRUGATED POLY	4'-8"	6'-10"	
6	BEDROOM 02	UPVC DOUBLE HUNG	3'-6"	4'-0"	uPVC	YES	NO	DEMOUNTABLE CORRUGATED POLY	2'-10"	6'-10"	
7	BEDROOM 02	UPVC DOUBLE HUNG	3'-6"	4'-0"	uPVC	YES	NO	DEMOUNTABLE CORRUGATED POLY	2'-10"	6'-10"	
8	UTILITY ROOM	UPVC DOUBLE HUNG	2'-2"	2'-2"	uPVC	YES	NO	DEMOUNTABLE CORRUGATED POLY	4'-8"	6'-10"	
9	UTILITY ROOM	UPVC DOUBLE HUNG	2'-2"	2'-2"	uPVC	YES	NO	DEMOUNTABLE CORRUGATED POLY	4'-8"	6'-10"	
10	KITCHEN	UPVC DOUBLE HUNG	3'-0"	3'-0"	uPVC	YES	NO	DEMOUNTABLE CORRUGATED POLY	3'-10"	6'-10"	
11	DINING	UPVC DOUBLE HUNG	3'-6"	4'-0"	uPVC	YES	NO	DEMOUNTABLE CORRUGATED POLY	2'-10"	6'-10"	
12	LIVING	UPVC DOUBLE HUNG	3'-6"	4'-0"	uPVC	YES	NO	DEMOUNTABLE CORRUGATED POLY	2'-10"	6'-10"	
13	LIVING	UPVC DOUBLE HUNG	3'-6"	4'-0''	uPVC	YES	NO	DEMOUNTABLE CORRUGATED POLY	2'-10"	6'-10"	

01 WINDOW SCHEDULE
A-600 N.T.S.

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LC			
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	¥	1614/DD/YY	
			Description
-	Gen	eral Note	10
	1. '	This draw	ing is the exclusiv

EMERGENCY SOCIAL HOUSING 2/3-BED UNITS VARIOUS LOCATIONS

DOOR SCHEDULE

NOT FOR CONSTRUCTIO

PROJECT NO. CW-A-MP.033

DATE November 2017 SCALE NA DRAWN BY Eug CHECKED BY Eug

DRAWING NO. A-601

MATHLE SOCIAL HOUSING: 2-BEDROOM UNIT DOOR SCHEDULE

DOOR No.	LOCATION	STYLE	SI	ZE	THICKNESS	MATERIAL	ARCHITRAVE	THRESHOLD	INTERIOR /EXTERIOR	STRUCTRU	AL OPENING	FINISHED	OPENING	ID	FRAME SIZE	NOTES
			WIDTH	HEIGHT						WIDTH	HEIGHT	WIDTH	HEIGHT			
1	PATIO	FIELDED 6-PANEL	3'-0"	6'-8"	1-5/8"	CEDAR	YES	YES	EXT	3'-4"	6'-10"	3'-2"	6'-9 1/2"		N/A	OLID PANEL IN-SWING w/ SURFACE FIX THRESHOLD
2	UTILITY ROOM	ALUMINIUM 1/2 GLASS JALOUSIE	3'-0"	6'-8"	2-1/4"	ALUMINIUM / GLASS	NO	YES	EXT	3'-4"	6'-10"	3'-2"	6'-9 1/2"		N/A	EXTERIOR DOOR C/W FRAME & HINGES
3	UTILITY ROOM	FIELDED 4-PANEL	2'-8"	6'-8"	1-3/8"	PINE	YES	NO	INT	3'-0"	6'-10"	2'-10"	6'-9 1/2"		N/A	
4	BEDROOM 02	FIELDED 4-PANEL	2'-8"	6'-8"	1-3/8"	PINE	YES	NO	INT	3'-0"	6'-10"	2'-10"	6'-9 1/2"		N/A	
5	1/2 BATH	FIELDED 4-PANEL	2'-4"	6'-8"	1-3/8"	CEDAR	YES	NO	INT	2'-6"	6'-10"	2'-4"	6'-9 1/2"		N/A	
6	BATHROOM	FIELDED 4-PANEL	2'-4"	6'-8"	1-3/8"	PINE	YES	NO	INT	2'-6"	6'-10"	2'-4"	6'-9 1/2"		N/A	
7	LINEN	FULL LOUVRE	2'-4"	6'-8"	1-3/8"	CEDAR	YES	NO	INT	2'-6"	6'-10"	2'-4"	6'-9 1/2"	·	N/A	
8	BEDROOM 01	FIELDED 4-PANEL	2'-8"	6'-8"	1-3/8"	PINE	YES	NO	INT	3'-0"	6'-10"	2'-10"	6'-9 1/2"		N/A	

01 DOOR SCHEDULE
A-601 N.T.S.

GENERAL NOTES

- STRUCTURAL DESIGN CRITERIA: The Design complies with the requirements of the Montserrat Building Code, 2015 International Building Code, 2015 International Residential code, ASCE 7-16 minimum design loads for structures, ACI 318-14 codes for structural concrete, TMS 402/602 Building codes Specs for masonry
- FOUNDATION: Footings/ Foundations to bear 6" min. into solid rock. Notify Engineer of any discrepancy in soil bearing before proceeding with the work.
- 3 SLABS ON GREADE: (Internal) 5" thick and reinforced with 200 x 200 / 6-6 Galv. welded wire mesh (unless noted otherwise -UNO)
 - (External) 4" thick and reinforced with 200 x 200 / 6-6 Galv. welded wire mesh
 - Joints shall be provided in all slabs and at maximum spacing of 36 times slab thicness according to the ACI Code
- 4 CONCRETE: All concrete to be regular weight with a min. design compressive strength of 3500 psi at 28 days (UNO). Contractor is responsible for the adequacy of forms and shoring, and for safe practice in their use and removal.
- REINFORCING STEEL: All reinforcing steel to conform to ASTM 615 Grade 60 min. (UNO); fabricated and placed in accordance with the CRSI and ACI 315 / ACI manuals of standard practice, respectively.
- MISC. STEEL: Anchor bolts cast in-situ, nuts and washers
 to be ASTM A36 (FY=36 ksi UNO); designed in accordance
 with the latest AISC "Specification For The Design, Fabrication
 And Erection Of Structural Steel For Buildings" and the AISC
 Code of Standard Practice.
- PREPARATION: All reinforcing steels shall be free of rust and contaminants. GC shall inform Engineer 24 hours prior to placing of concrete for inspection
- 8 Timber/Wood MEMBERS: All timber members to be Southern
 Pine No. 2 or better.
 Timbers shall be pressure treated in accordance to the AWPA
 U1 R317 IRC Code & CCA (insect treatment). All timber members

must bare the kiln dry 19% HT moisture SPIB No. 2 stamp.

9 Contractor is responsible for the co-ordination of the structural, architectural, electrical, mechanical, plumbing and all other relevant drawings. All grade lines, levels, conditions and dimensions are to be verified prior to construction and confirmed on site. All potential conflicts, errors or

inconsistencies shall be transmitted to the architect/engineer

before commencing work.

DO NOT SCALE THESE DRAWINGS — USE ONLY FIGURED DIMENSIONS

- 10 Absolutely no cutting of any structural member, once in place without the approval of the structural engineer.
- 11 Engineer to be notified 48 hours prior to placing of any concrete.

DESIGN CRITERIA AND LOADINGS

- 1. DESIGN CRITERIA:
 - BUILDING CODE: IBC 2015

MONTSERRAT BUILDING CODE

CONCRETE STRUCTURE: ACI BUILDING CODE (ACI 318-14)

REQUIREMENTS FOR REINFORCED CONCRETE.

MASONRY STRUCTURE: ACI BUILDING CODE & TMS 402/602

REQUIREMENTS FOR MASONARY STRUCTURES.

NOTES

2. DESIGN LOADS:

BUILDING CODE: IBC 2015, IRC

Wind loads up to 182 mph, live load - 20 PSF, &

SUPERIMPOSED ROOF LIVE LOAD: 20 PSF

SUPERIMPOSED ROOF DEAD LOAD: 15 PSF

SUPERIMPOSED INTERIOR FLOOR LIVE LOAD: 30 PSF

SFISMIC

OCCUPANCY CATEGORY: II

IMPORTANCE FACTOR: 1.00

RESPONSE ACCELERATION, SS: 1.643 (MBC)

RESPONSE ACCELERATION, S1: 0.485 (MBC)

SITE CLASS: D

RESPONSE COEFFICIENT, SDS: 1.096

RESPONSE COEFFICIENT, SD1: 0.589

SEISMIC DESIGN CATEGORY: D

SEISMIC FORCE RESISTING SYSTEM: Special reinforced masonry walls

RESPONSE MODIFICATION FACTOR, R: 5 (ASCE 7-16, Tbl. 12.2-1, A.7)

DESIGN BASE SHEAR, V: 0.22 W

ANALYSIS PROCEDURE: EQUIVALENT STATIC

- 3. GEOTECHNICAL CRITERIA:
- 1. FOUNDATION TYPE: SPREAD FOOTINGS
- 2. VERTICAL BEARING PRESSURE: 2000 PSF (Service, MCB, Table 13-1, Type 6 materials)
- LATERAL ACTIVE SOIL PRESSURE: 35 PCF (UBC Table 1610.1 SW or GW uses, 30; use 35 based on experience)
- 4. LATERAL AT-REST SOIL PRESSURE: 60 PCF (UBC Table 1610.1 SW or GW)
- 5. LATERAL PASSIVE SOIL PRESSURE: 300 PCF
- 6. VERTICAL BEARING INCREASE: 33% (WIND OR EARTHQUAKE FORCES)
- 7. FOOTINGS SHALL BE PLACED A MINIMUM OF 6? INTO BEDROCK (PER MCWL)

CONSTRUCTION LAYOUT

FOR THE ACCURATE LOCATION AND ORIENTATION OF MASONRY WALLS, AND STRUCTURES REFER TO ARCHITECTURAL DRAWINGS.

COORDINATION

STRUCTURAL DRAWINGS SHALL BE WORKED TOGETHER WITH ARCHITECTURAL, MECHANICAL AND ELECTRICAL DRAWINGS. DISCREPANCES SHALL BE BROUGHT TO THE ATTENTION OF THE ARCHITECT—ENGINEER BEFORE PROCEEDING WITH THE WORK. NO DIMENSIONS SHALL BE SCALED FROM DRAWINGS.

REINFORCEMENT CLEARANCE

STRUCTURAL STEEL

- 1. ANCHOR BOLTS AND THRU BOLTS SHALL CONFORM TO ASTM A307 OR ASTM A36
- 2. ALL BOLTS, NUTS, AND WASHERS SHALL BE HOT-DIP GALVANIZED ACCORDING TO ASTM A153.

STRUCTURAL TIMBER MEMBERS

ALL ROOF MEMBERS TO BE SECURED TO THE BEAMS OR OTHER STRUCTURAL MEMBERS
WITH HURRICANE STRAPS/CLIPS ON BOTH SIDES OR WHAT IS SPECIFIED IN THE DRAWINGS.

MASONRY

- MASONRY UNITS SHALL CONFORM TO ASTM C90, TWO CELL HOLLOW, LOAD BEARING CONCRETE BLOCK OF 8 INCHES BY 16 INCHES. CONCRETE MASONRY SHALL HAVE AN AVERAGE PRISM STRENGTH (f'm) OF 1500 PSI.
- 2. THE PLACEMENT OF MASONRY UNITS SHALL BE "RUNNING BOUND" TYPE. HORIZONTAL AND VERTICAL JOINTS SHALL BE THREE—EIGTHS ON AN INCH IN THICKNESS. MORTAR USED TO BOND MASONRY SHALL BE TYPE M AND SHALL HAVE A MINIMUM COMPRESSIVE STRENGTH OF 2500 PSI. PROPERTIES AND PROPORTIONS SHALL COMPLY WITH ASTM C270. FOR INTERIOR WALLS THE MORTAR SHALL BE TYPE M OR S.
- HORIZONTAL REINFORCEMENT SHALL BE TRUSS OR LADDER TYPE AT 8" OR 16" C/C. (REFER TO DRAWNGS)
- 4. GROUT FOR FILLED CELLS SHALL BE A PEAROCK MIX WITH A MAXIMUM AGGREGATE SIZE OF 3/8 INCH AND A 28 DAY COMPRESSIVE STRENGTH OF 2500 PSI.
- 5. HORIZONTAL JOINT REINFORCING SHALL EXTEND INTO CONCRETE COLUMNS.

ROOF SHEATHING

- NAILING PATTERN SHALL COMPLY WITH THE BAHAMAS BUILDING CODE. USE 5/8" PLYWOOD ROOF SHEATHING NAILED EITHER TO WOOD TRUSSES OF 2"X4" WOOD STRAPPINGS WITH 8D COMMOM NAILS AT 6" C/C AT PANEL EDGES AND AT INTERMEDIATE SUPPORTS. NAIL SPACING SHALL BE 4" C/C AT GABLE ENDS.
- 2. SHEATHING SHALL BE CONTINUOUS OVER TWO OR MORE SPANS WITH FACE GRAIN PERPENDICULAR TO SUPPORTS AND SHALL HAVE STAGGARD JOINTS.

STRUCTURAL TIMBER

ALL TIMBER SHALL BE PRESSURE TREATED No. 2 SOUTHERN YELLOW PINE OR BETTER HAVING THE FOLLOWING MIN. PROPERTIES WHEN MOISTURE CONTENT EXCEEDS 19%.

Fb = 1500 PSI (EXTREME FIBER BENDING/SINGLE MEMBER)

Ft = 800 PSI (TENSION PARALLEL TO GRAIN)

Fv = 95 PSI (HORIZONTAL SHEAR)

E = 1,500,000 PSI (MODULUS OF ELASTICITY)

TYPICAL DETAILS

TYPICAL DETAILS APPLY AT ALL APPROPRIATE LOCATIONS UNLESS OTHERWISE NOTED ON DRAWINGS.

PWD

Public Works Department

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MATHLE

2 & 3 Bedroom Single Family Dwellings Various Locations Montserrat

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 Do NOT scale drawings.
- The architect is not responsible for the dimensions indicated on Site Plans unless taken directly from a REGISTERED boundary survey prepared by a licensed land surveyor.
- This drawing to be read and coordinated with all other relevant consultant's drawings and project documentation.

No.	Description	Date	
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GENERAL NOTES


 Project number
 CW-A-MP.33

 Date
 23 Nov 17

 Drawn by
 Eug

 Checked by
 JB

 Scale
 N.A.

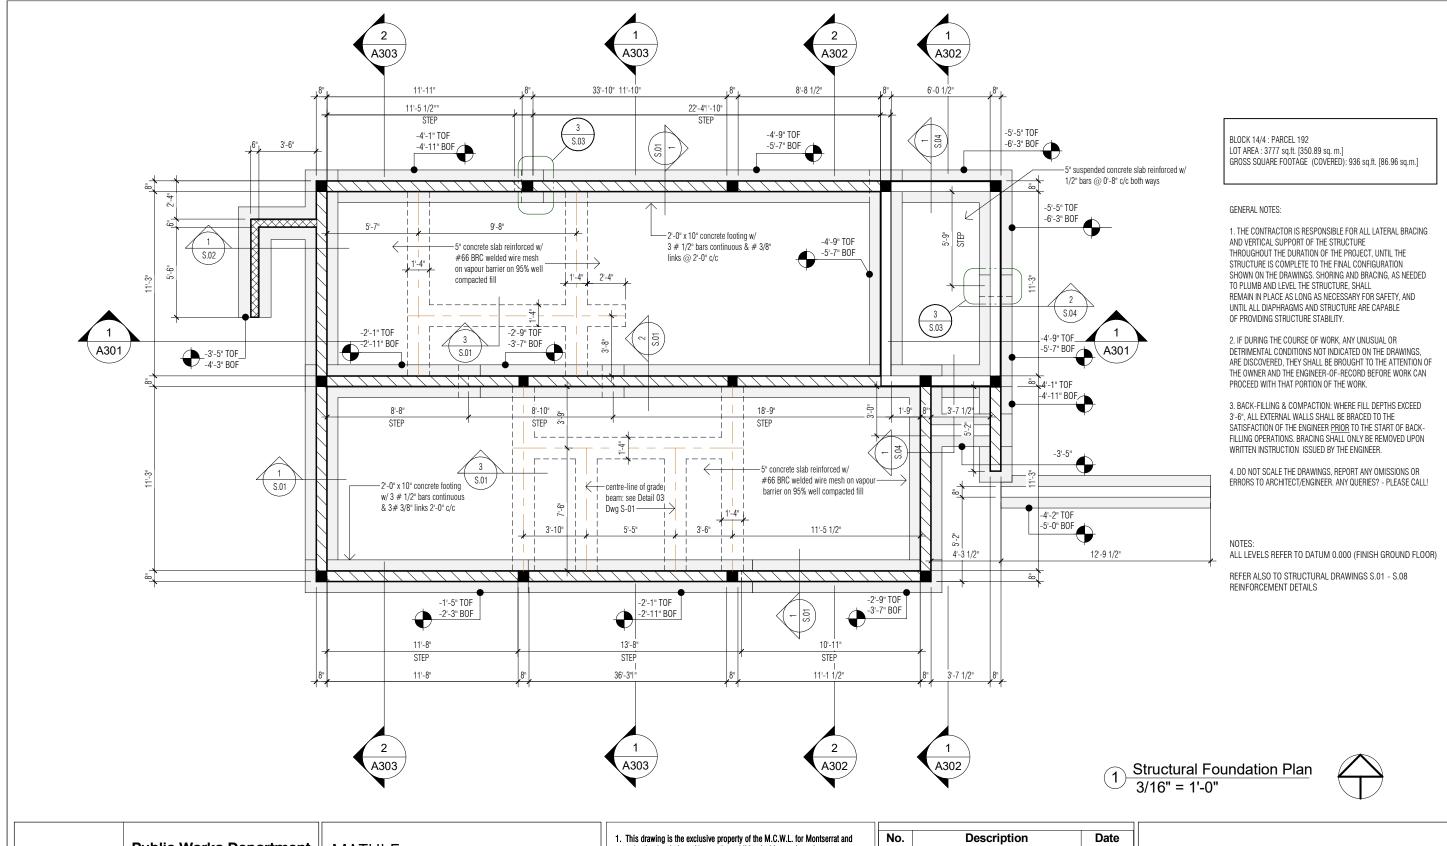



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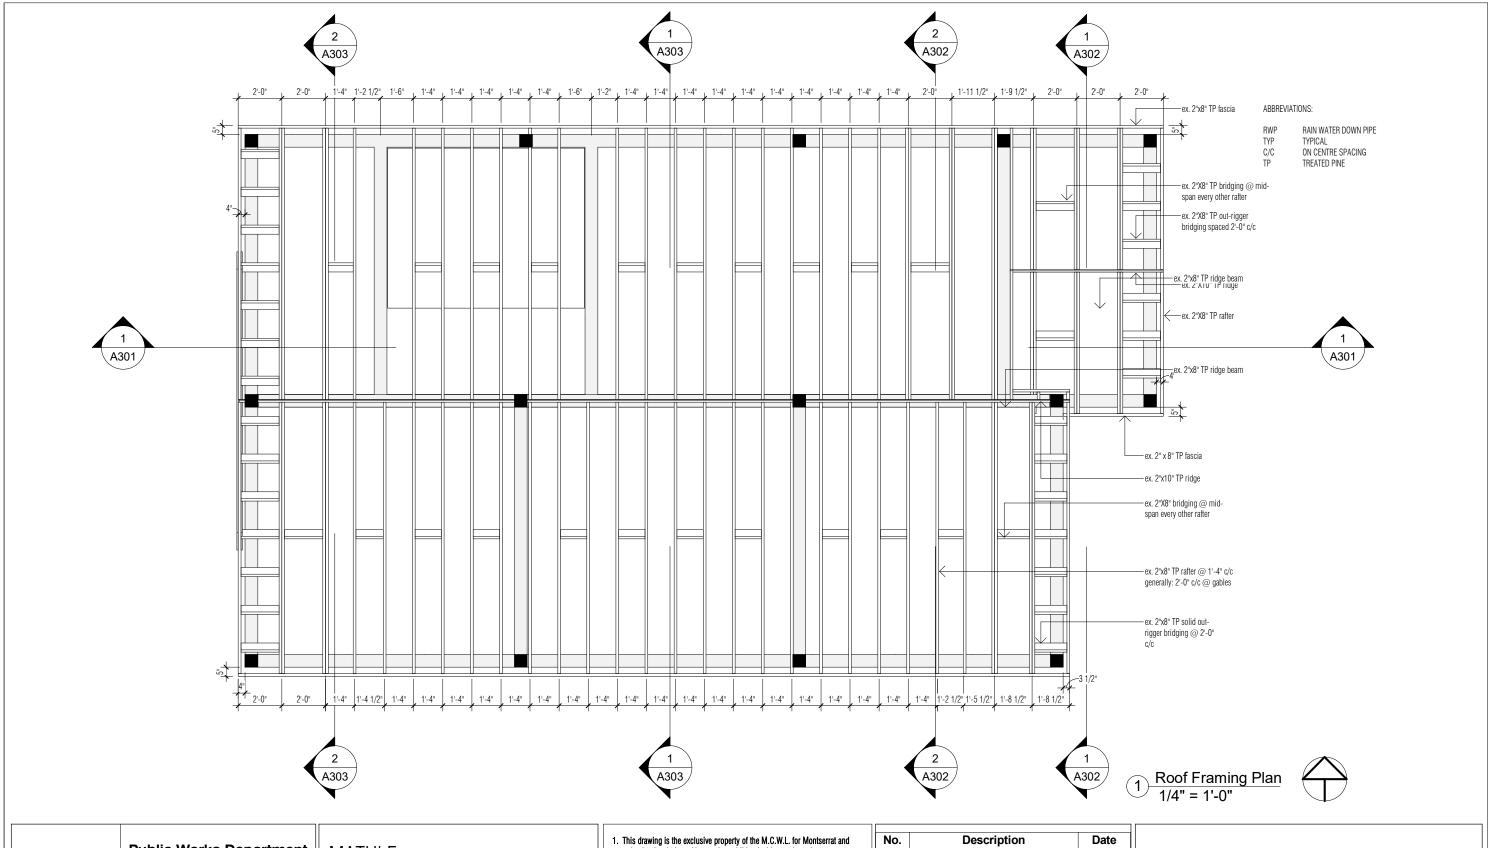
Social Housing - 2 Bedroom Unit @ Lot 157 Lookout, St. Johns, Montserrat

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No.	Description	Date
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STRUCTURAL FOUNDATION PLAN

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-	Date	23-Nov-17		S201
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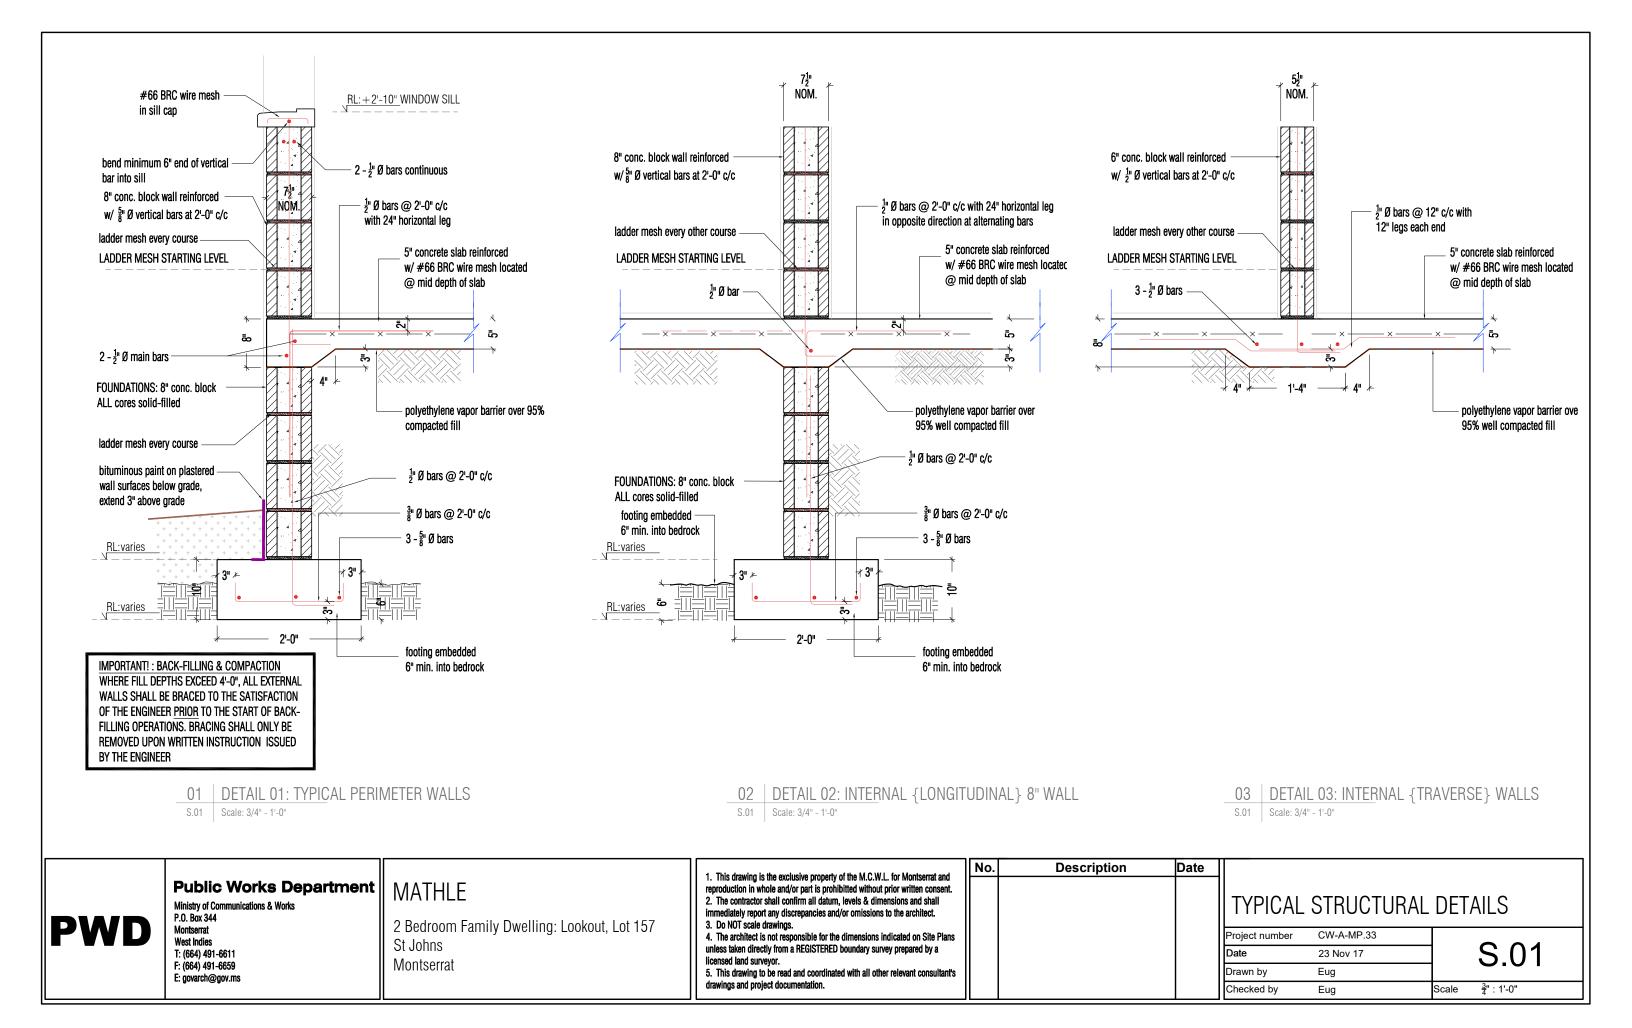
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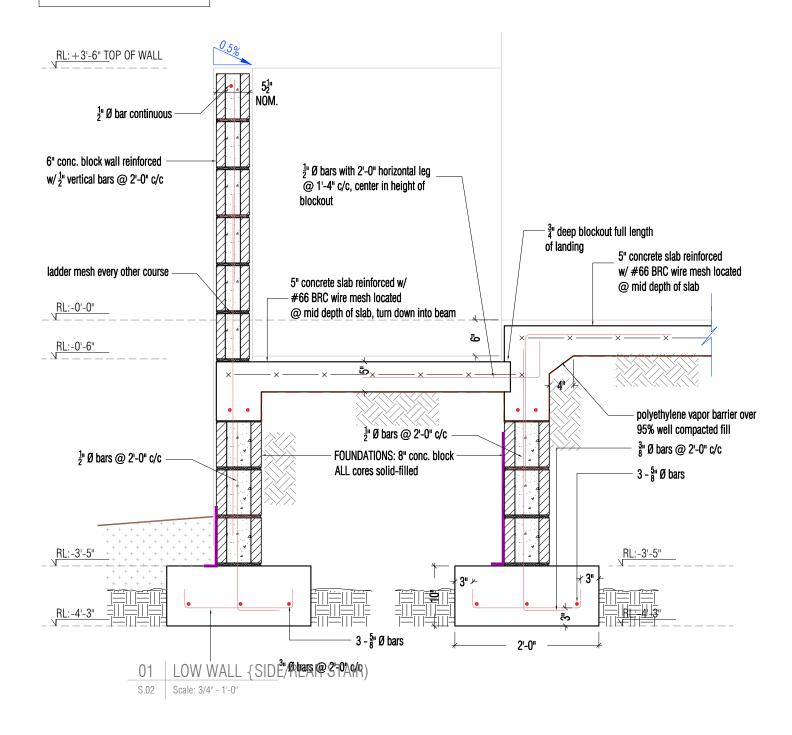
Description	Date
	Description

ROOF FRAMING PLAN

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\dashv	Date	23-Nov-17		Ç	5202
\dashv	Drawn by	Eug		•	
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NOTE: ALL BLOCKS @ TOP COURSE SHALL BE SOLID FILLED w/ CONCRETE





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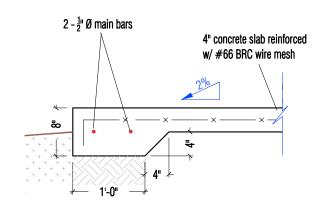
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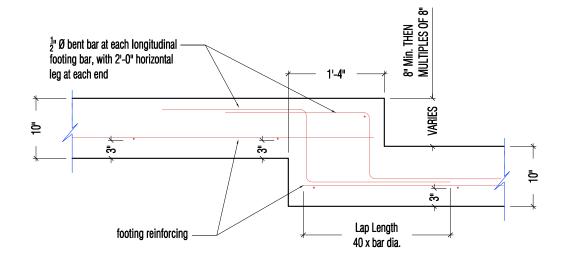
2 Bedroom Family Dwelling: Lookout, Lot 157 St Johns Montserrat

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No.	Description	Date			
			TYPICAL	STRUCTURAL	DETAILS
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			Date	23 Nov 17	S.02
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02 | EDGE OF RAMP/WALKWAYS

S.03 Scale: 3/4" - 1'-0"

03 | FOOTING STEP DETAIL

S.03 Scale: 3/4" - 1'-0"



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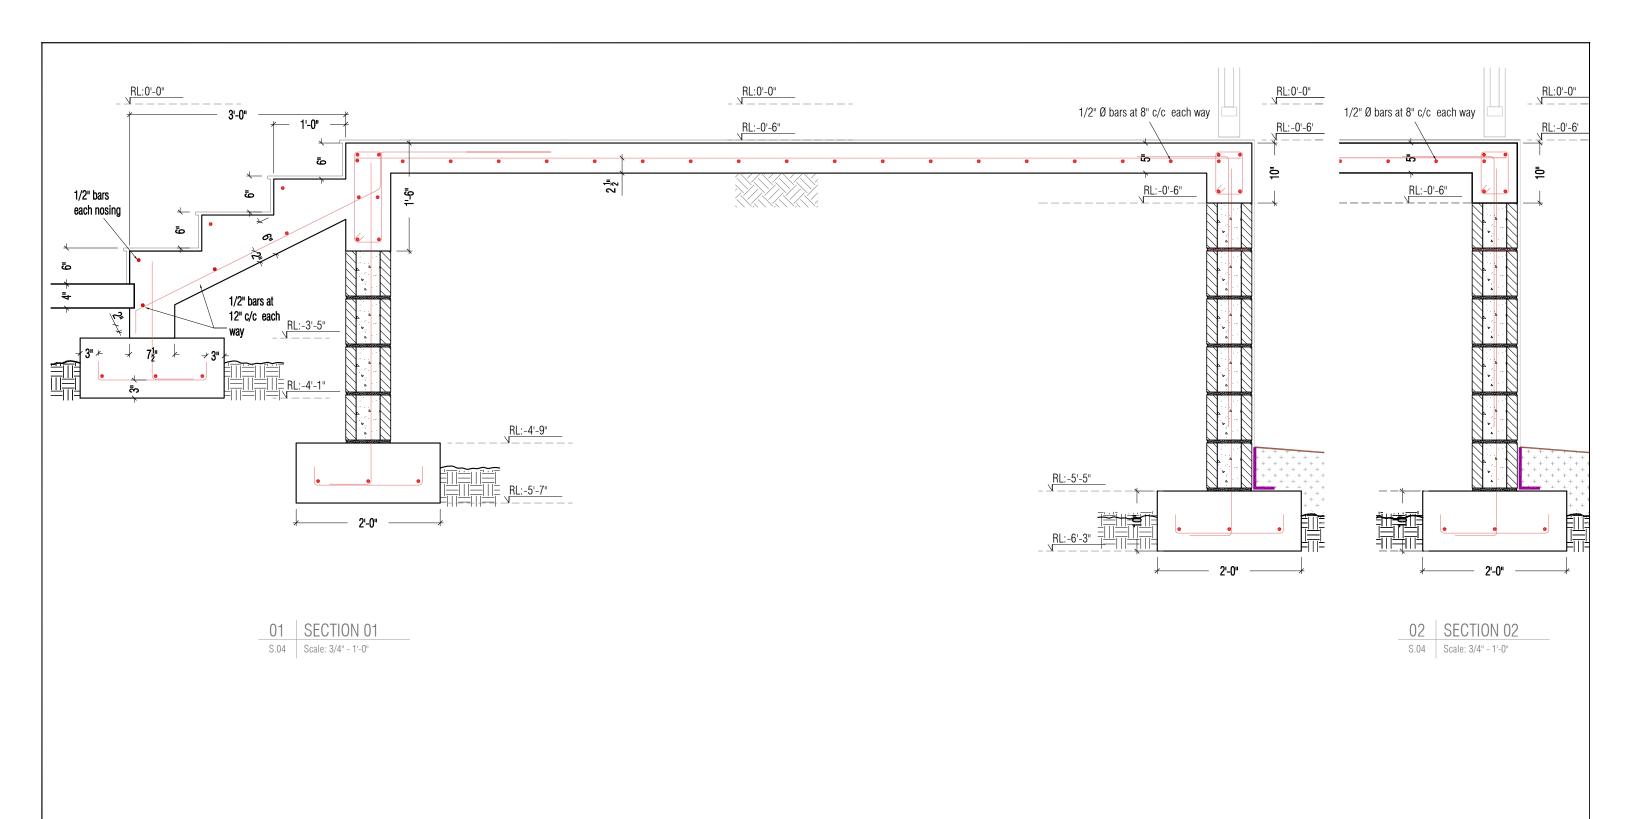
2 Bedroom Family Dwelling: Lookout, Lot 157 St Johns Montserrat

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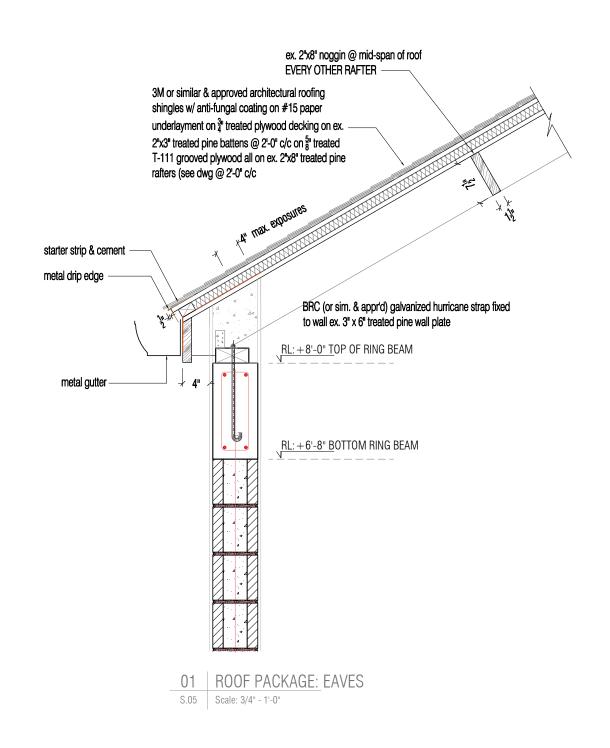
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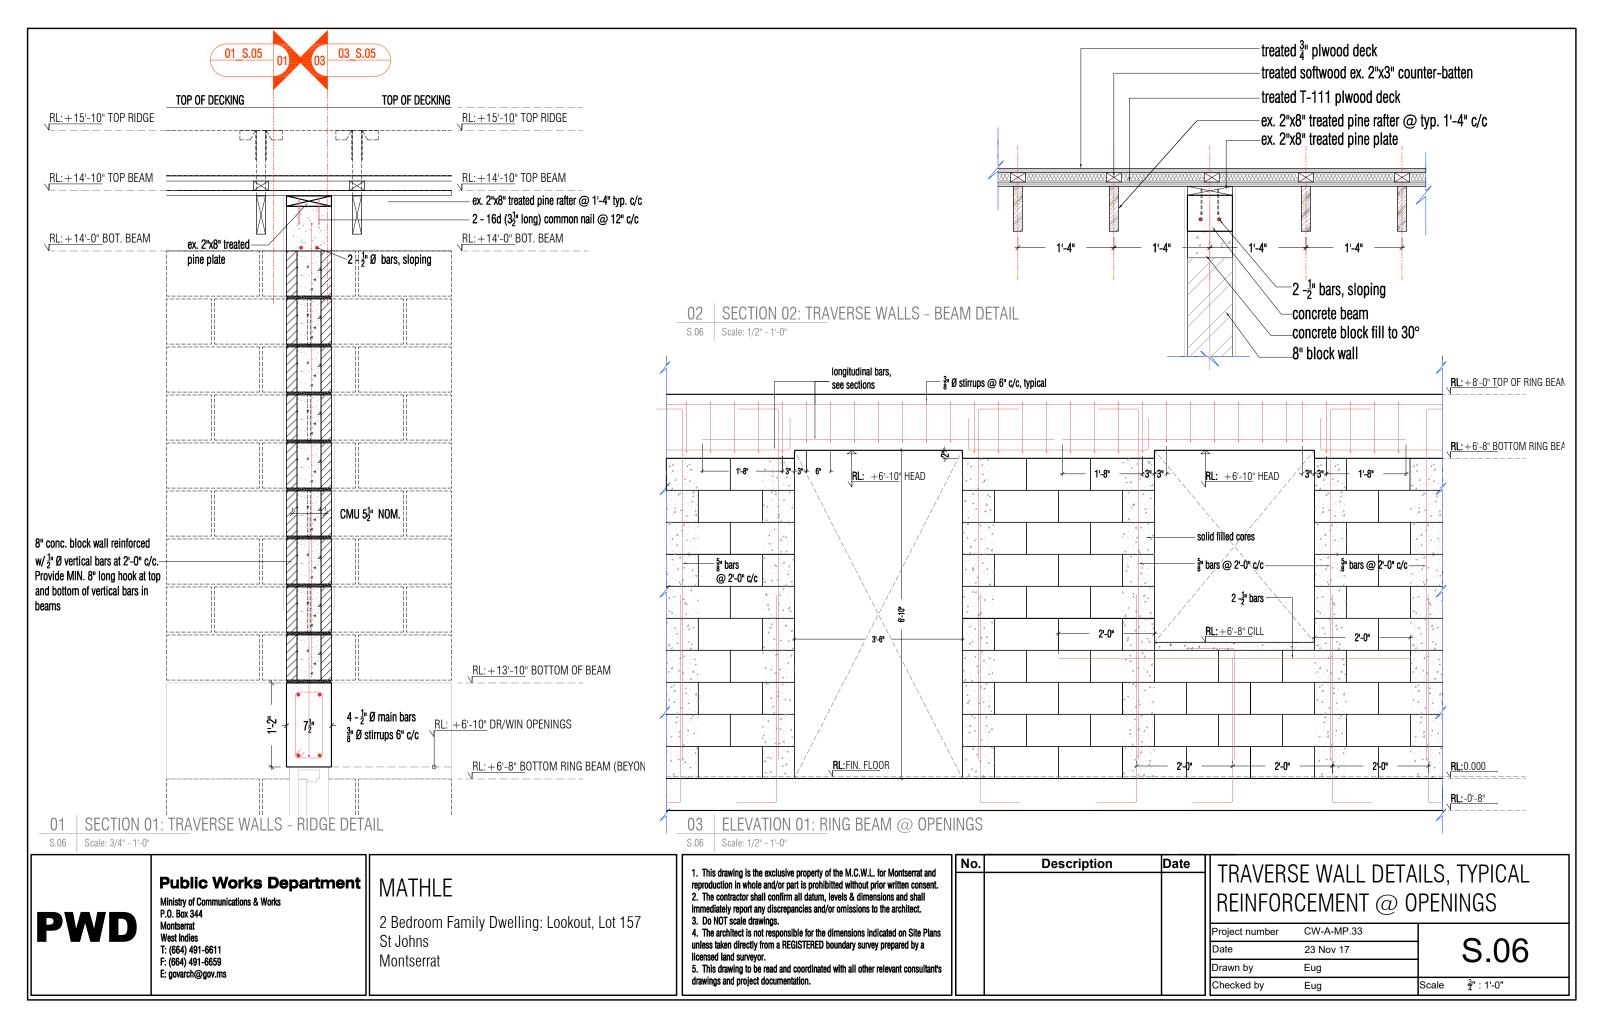
2 Bedroom Family Dwelling: Lot 157 Lookout, St Johns Montserrat


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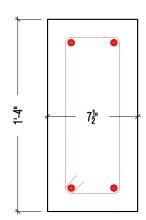
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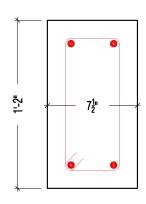
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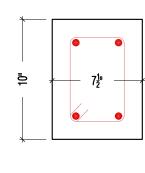
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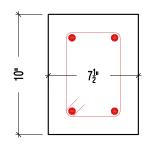










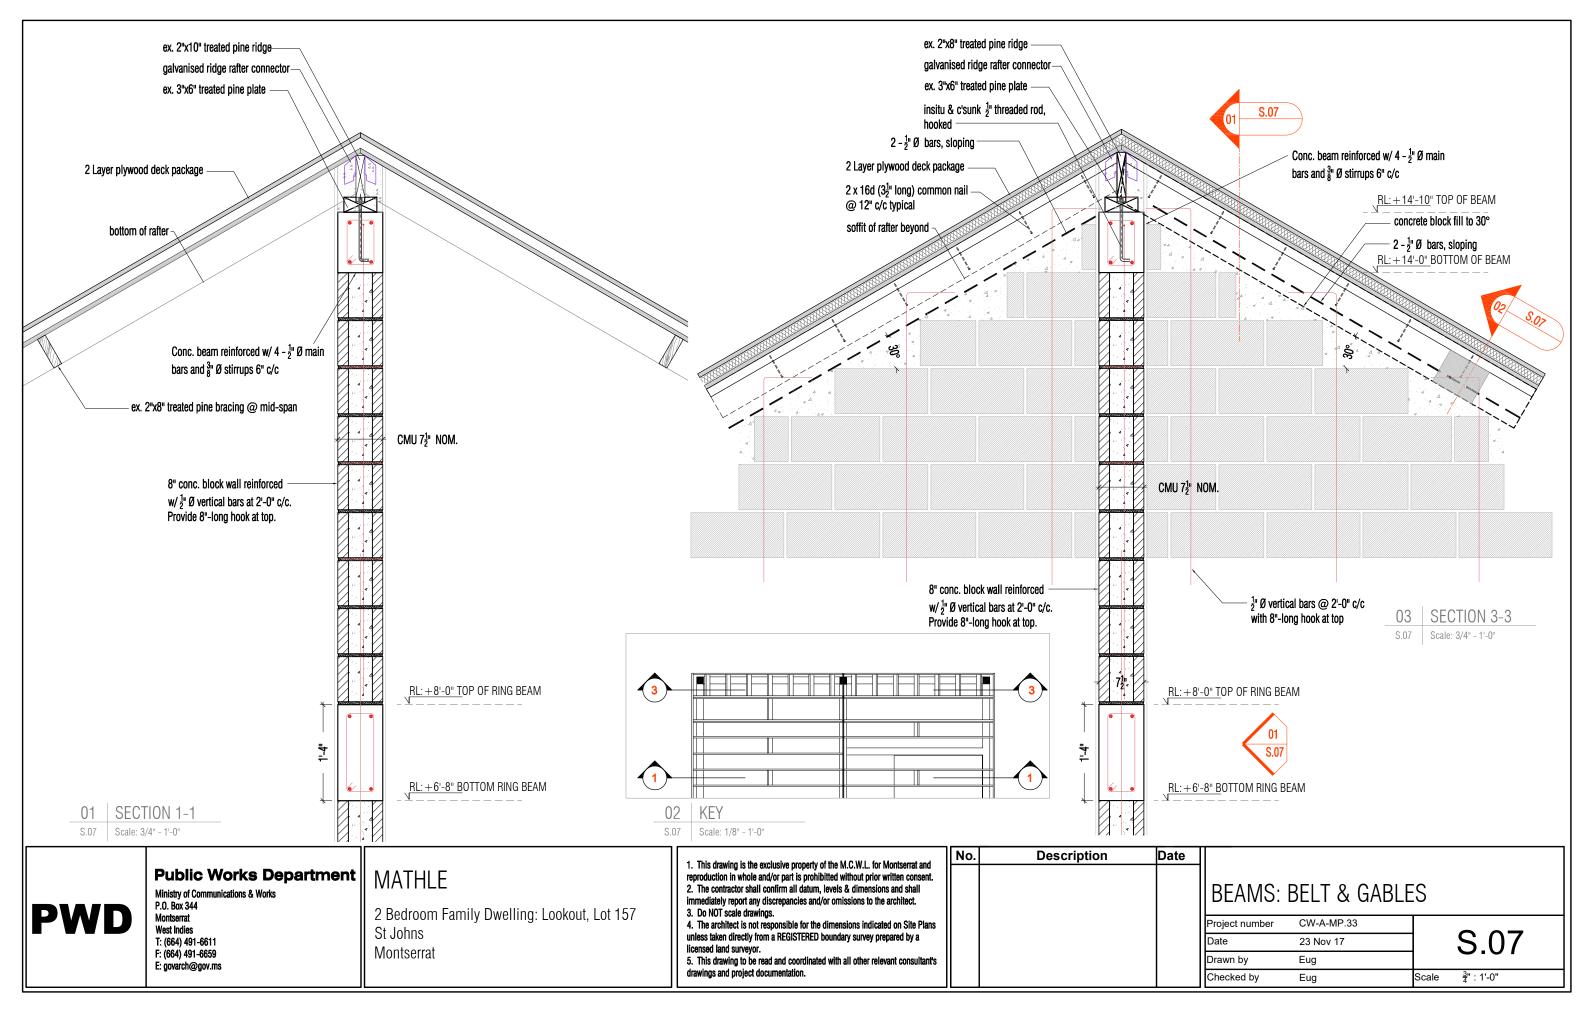

01	BEAM A: WALLS
S 08	Scale: 1 1/2" 1' 0"

S.08 Scale: 1 1/2" - 1'-0"

S.08 Scale: 1 1/2" - 1'-0"

04 | COLUMN S.08 Scale: 1 1/2"- 1'-0"



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2 Bedroom Family Dwelling: Lookout, Lot 157 St Johns Montserrat

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 5. This drawing to be read and coordinated with all other relevant consultants
- drawings and project documentation.

No.	Description	Date	DEANA/ C				
			BEAM/ COLUMN SIZES,				
			MISCELLANEOUS DETAILS				
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